

SEE SHEET T-1 FOR ADDITIONAL ABBREVIATIONS

10 July 2024

KEY PLAN

702.4 DOOR ELEVATIONS SCALE: 1/4" = 1'-0"

NOTE: ALL STEEL DOORS AND DOOR FRAMES TO BE GALVANIZED.

CEILING FINISH SCHEDULE 24"x24"x 5/8" ARMSTRONG FINE FISSURED HUMIGUARD PLUS, no. 1728 SQUARE EDGE/PRELUDE XL GRID NOT USED. 24"x24"x 5%" VINYL FACED GYPSUM PANEL, WHITE STIPPLE FINISH, AL PRELUDE PLUS GRID. TYPE 4 1/8" MOISTURE RESISTANT GYPSUM BOARD WITH HAT CHANNELS/"C" CHANNELS FRAMING SYSTEM TYPE 5 5/8" GYPSUM BOARD WITH HAT CHANNELS/"C" CHANNELS FRAMING SYSTEM. ACOUSTICAL SPRAY MATERIAL - SEE ROOM FINISH SCHEDULE FOR COLOR. EIFS EXTERIOR INSULATION AND FINISH SYSTEM OVER  $\frac{5}{8}$ " DENS-GLASS SHEATHING. (1) PROVIDE TYPE 1 CEILING UNLESS OTHERWISE NOTED. (2) PROVIDE 24" x 24" CEILING ACCESS DOOR IN EACH SPACE WITH DRYWALL CEILING.

Storage

SLOPE TO MATCH EXISTING-

SLOPE TO MATCH EXISTING-

SLOPE TO MATCH EXISTING-

Courtyard

LEGEND - REFLECTED CEILING PLAN 2 CEILING TYPE - SEE CEILING FINISH SCHEDULE XX'-X" CEILING HEIGHT ABOVE FINISH FLOOR SLOPED CEILING LS XX'-X" CEILING HEIGHT ABOVE FINISH FLOOR - LOW SIDE HS XX'-X" CEILING HEIGHT ABOVE FINISH FLOOR - HIGH SIDE 2 x 2 ACOUSTICAL TILE AND GRID GYPBOARD CEILING MOISTURE RESISTANT GYPBOARD CEILING EXPSTR EXPOSED STRUCTURE DROP-IN TRAY FOR VIDEO MONITOR CEILING BRACKET DROP-IN TRAY FOR LCD PROJECTOR CEILING BRACKET FLUORESCENT LIGHT FIXTURE RECESSED LIGHT FIXTURE - SURFACE MOUNTED LIGHT FIXTURE - WALL MOUNTED LIGHT FIXTURE ▼ ▼ ▼ CEILING MOUNTED TRACK LIGHTING SUPPLY AIR GRILLE RETURN AIR GRILLE EXHAUST FAN

SMOKE SENSOR

RELOCATE HVAC UNIT - SEE MECHANICAL PLANS.

— EXISTING HVAC UNIT TO REMAIN-

NOTE: WORK: NEW: CEILING GRID AROUND EXISITNG HVAC

Art Room

8'-6"

--EXISTING -- HVAC -- UNIT -- TO -- REMAIN :-

Corridor

AND ELECTRICAL FIXTURES AND EQUIPMENTS

SECURITY CAMERA


School to High

Project No. 22415 10 July 2024 Drawing no.


702.1 REFLECTED CEILING PLAN


3 mm PVC BAND (TYP) — 5 mm HOLES @ 11/21 O.C. OPEN ADJUSTABLE SHELVES ----1" THICK PARTICLEBOARD CORE SHELF WITH 3mm PVC BAND ON FRONT EDGE AND 1mm PVC BAND ON OTHER 3 SIDES CLEAR POLYCARBONATE LOCKING SHELF SUPPORT HD DOUBLE PIN PC CLEAF ALLEN FIELD NO. 55536 HIGH PRESSURE PLASTIC LAMINATE ALL EXPOSED SURFACES 1 1/8" THICK HIGH PRESSURE LAMINATE
COUNTERTOP WITH 3 MM FRONT EDGE
WITH 3/4" THICK HPL BACK SPLASH
PROVIDE EXTERIOR GRADE
PLYWOOD TOP AND SPLASH
AT ALL COUNTERS WITH SINKS ACCURIDE NO. 3832 OR CONTROL OF THE DRAWER O SEMI-RECESSED DOOR —— AND DRAWER PULL DRAWER () DRAWER O HIGH PRESSURE LAMINA E 3/4 " PARTICLE BOARD CORE . DOORS AND DRAWER DRAWER ()() EDGE SHALL BE 3 mm PVC DRAWER O S¢LID WO¢D ↓


702.3 34" BASE CABINET SCALE: 1 1/2" = 1'-0"

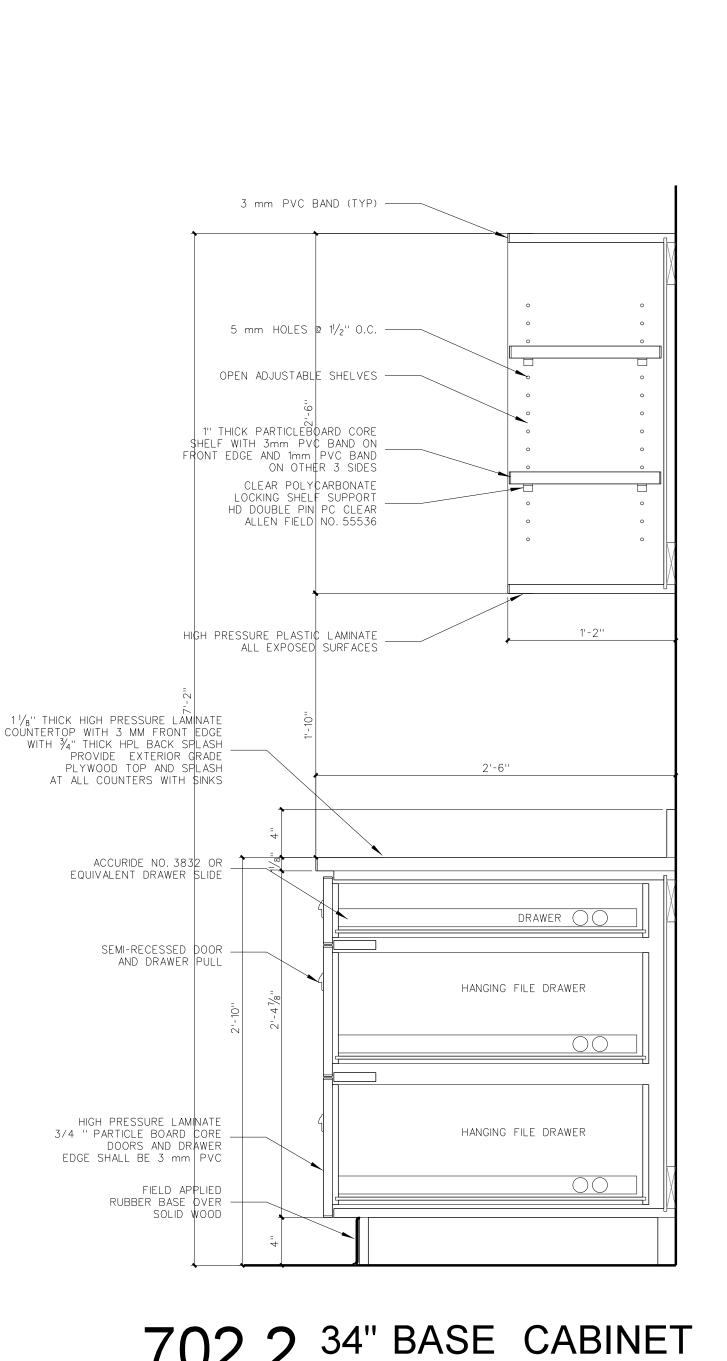

34" BASE CABINET
NOTE: 30" DEEP
SCALE: 1 1/2" = 1'-0"

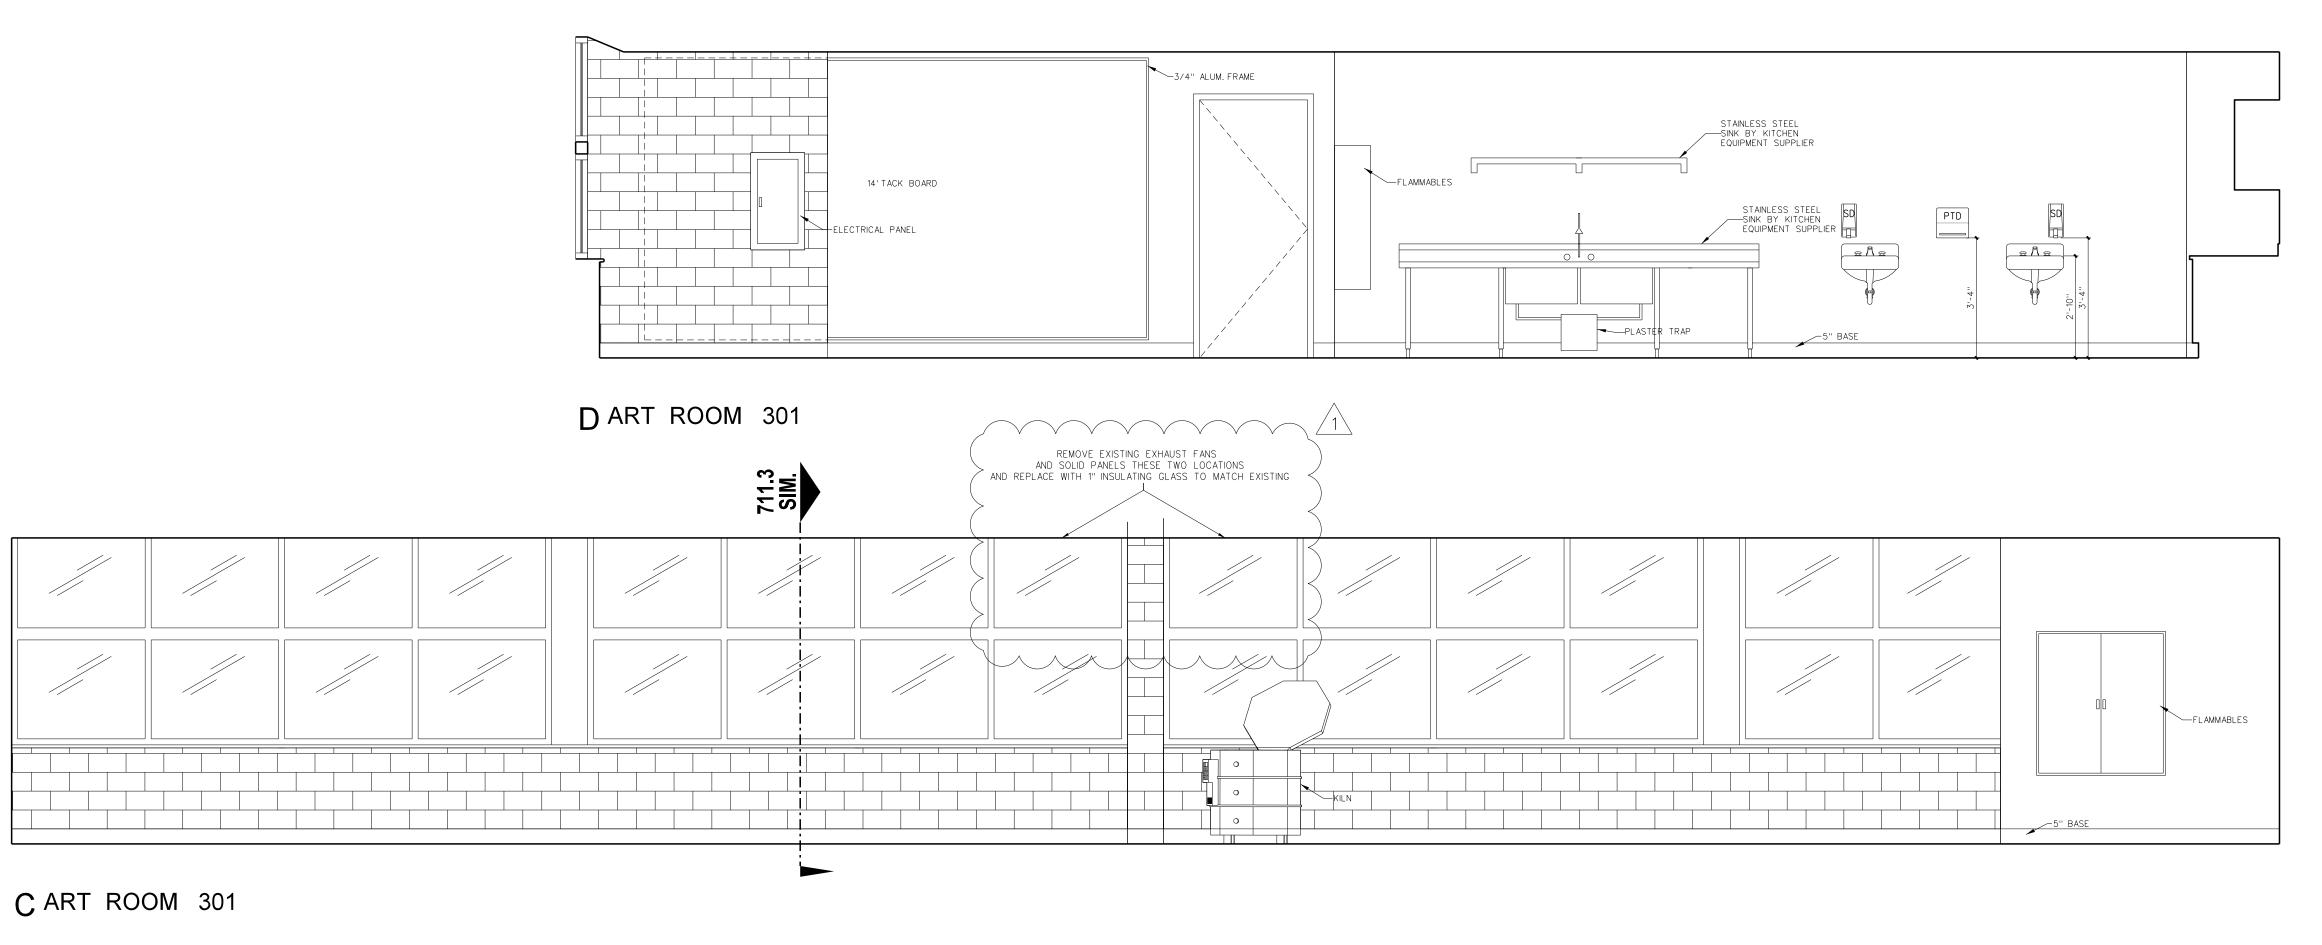


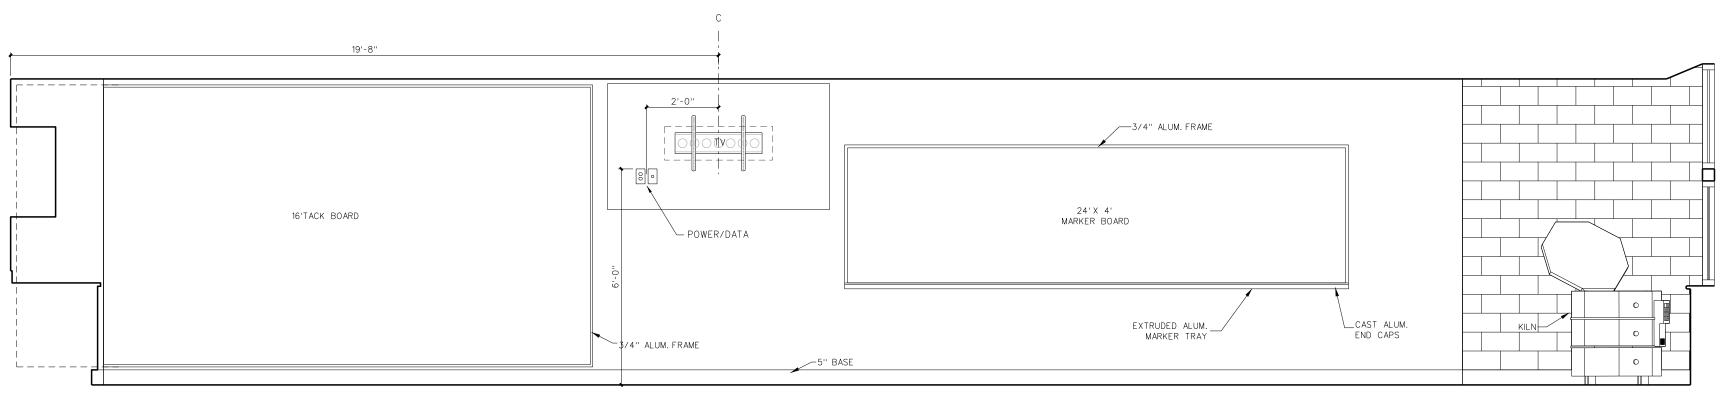

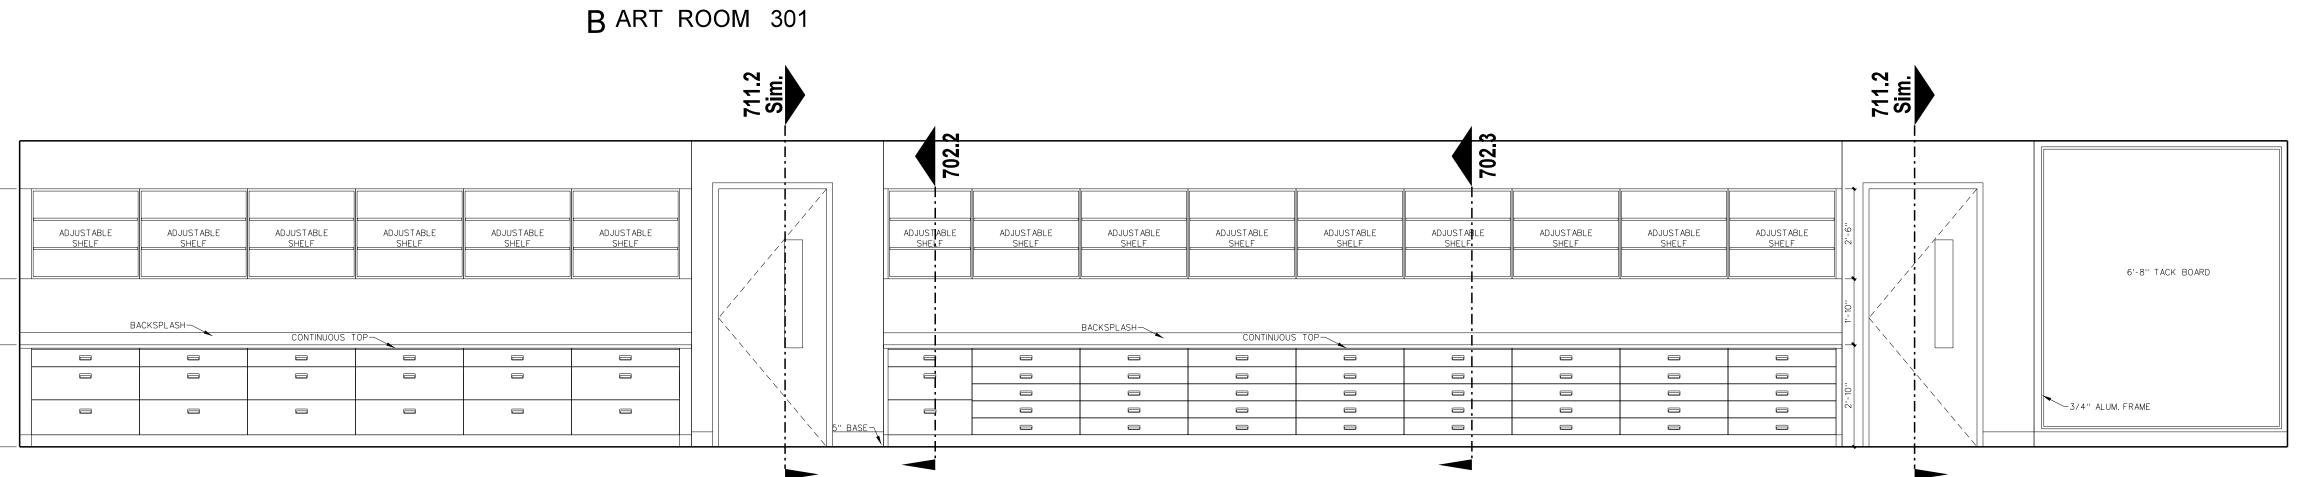


A ART ROOM 301

703.1 ART ROOM INTERIOR ELEVATIONS

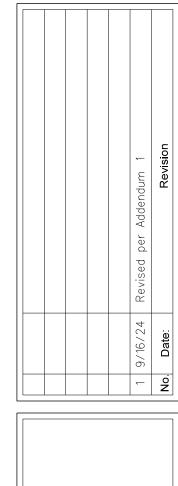

HITE 3880 GIBTES
ARCHITECTURE / PLANNING / TECHNOLOGY
2600 Meridian Drive / Greenville, NC 27834 / tel (252) 757-0333

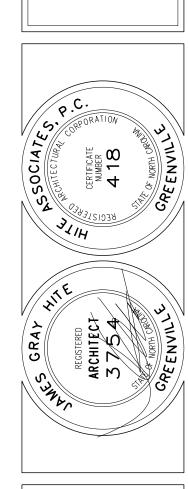

Art Room and Foods Lab Alterations to

East Carteret High School
3263 Hwy. 70, Beaufort, NC 28516
Carteret County Schools / North Carolina

Project No.
22415

Date:
10 July 2024

Drawing no.


Drawing no.

## **GENERAL DEMOLITION NOTES:**


- 1. GC TO CONSTRUCT TEMPORARY INSULATED SOLID DUSTPROOF PARTITIONS WHERE REQUIRED TO SEPARATE DEMO AREAS FOR NOISE CONTROL AND DIRT/DUST CONTAINMENT. PARTITIONS SHALL BE PROVIDED WITH DUSTPROOF DOORS AND SECURITY LOCKS IF REQUIRED TO MAINTAIN SAFETY. EGRESS AND SECURITY.
- 2. SEE ENLARGED DEMOLITION PLANS, ROOF DEMOLITION AND EXTERIOR ELEVATIONS, PME DRAWINGS, ETC FOR ADDITIONAL DEMOLITION SCOPE OF WORK REQUIREMENTS.
- 3. SEE SPECIFICATIONS SECTION 02070 FOR MORE INFORMATION ON SELECTIVE DEMOLITION AND CONSTRUCTION ACTIVITIES.
- 4. GENERAL CONTRACTOR SHALL COMPLY WITH ALL APPLICABLE LOCAL, STATE, AND OR REGULATORY AGENCIES, CODES, AND REGULATIONS FOR NEW CONSTRUCTION AND DEMOLITION.
- 5. PRIOR TO REMOVAL OR CUTTING OF OPENINGS THROUGH STRUCTURAL WALLS OR SLABS, CONTRACTOR SHALL PROVIDE ADEQUATE SHORING FOR THE ROOF AND ANY OTHER STRUCTURAL LOADS. SUPPORTS WILL NOT BE REMOVED UNTIL NEW STRUCTURAL SYSTEMS ARE IN PLACE.
- 6. CARE SHALL BE TAKEN DURING CONSTRUCTION NOT TO DAMAGE ANY EXISTING STRUCTURAL MEMBERS OR THEIR SUPPORTS, THE ARCHITECT AND OWNER REPRESENTATIVE WILL BE NOTIFIED IMMEDIATELY IF ANY DAMAGE SHOULD OCCUR.
- 7. GC IS RESPONSIBLE FOR NOTIFYING OWNER REPRESENTATIVE OF ANY BUILDING UTILITY DISTURBANCES, AND PROVIDE ADEQUATE INTERIM UTILITIES.
- 8. REMOVE ALL EXISTING MARKERBOARDS, BULLETIN BOARDS, DISPLAY BOARDS AND MAP RAILS AND ACM MASTIC BEHIND THEM. REFINISH WALLS TO MATCH EXISTING ADJACENT SURFACES. PROVIDE NEW MARKER AND BULLETIN BOARDS AS SCHEDULED OR SHOWN ON DRAWINGS.
- 9. CONTRACTOR SHALL TURN OVER ALL SALVABLE ITEMS TO OWNER AS DIRECTED.
- 10. CONTRACTOR SHALL COMPLETE ANY AND ALL DEMOLITION AND PATCHING AND REPAIRS REQUIRED FOR A COMPLETE JOB, WHETHER INDICATED SPECIFICALLY BY KEY NOTES OR NOT DEMOLITION AND REMOVAL REQUIRED INCLUDES ANY CONSTRUCTION SHOWN TO REPLACE EXISTING AND SHOWN ON OTHER DRAWINGS.
- 11. DEMOLISH ANY EXISTING UNUSED PLUMBING VENTS. PATCH AND REPAIR ROOF AS REQUIRED. COORDINATE WITH PLUMBING CONTRACTOR.
- 12. IDENTIFICATION AND REMOVAL OF ASBESTOS CONTAINING MATERIAL TO BE COMPLETED BY CONTRACTOR PRIOR TO ANY DEMOLITION OR CONSTRUCTION. CONTRACTOR TO REVIEW OWNER AHERA DOCUMENTS TO VERIFY SCOPE PRIOR TO COMMERCIAL WORK.
- 13. EXISTING EXHAUST FANS TO BE ABANDONED ARE TO BE REMOVED. RESULTING ROOF PENETRATIONS ARE TO BE PATCHED AND REPAIRED TO MATCH EXISTING AS REQUIRED. SEE MECHANICAL DRAWINGS. FIELD VERIFY EXISTING ROOF CONSTRUCTION PRIOR TO BID.

## KEY NOTES FOR DEMOLITION PLAN

- 1 REMOVE EXISTING DOOR AND FRAME.
- (2) REMOVE LOWER CABINETS AND COUNTERTOPS.
- (3) REMOVE UPPER CABINETS.
- (4) REMOVE SINKS AND LEAD PIPES TO BELOW FLOOR, CAP AND PATCH.
- 5 REMOVE STOVES AND POWER SERVICES.
- 6 REMOVE PORTION OF EXISTING WALL AS INDICATED TO STRUCTURAL BEAM OR CONCRETE DECK ABOVE.
- REMOVE KILN HOOD AND EXHAUST DUCT AND FAN.
- 8 REMOVE ALL EXISTING FLOOR TILE, INCLUDING ACM TILE AND ACM ADHESIVE FROM CONCRETE FLOOR.
- 9 REMOVE ALL EXISTING CEILING TILE AND GRID.
- 10) REMOVE MARKERBOARDS AND CABINETS. REMOVE ACM MASTIC FROM BEHIND EXISTING BOARDS.
- 11) REMOVE BOOKCASES.
- (12) REMOVE STORAGE CABINETS.
- (13) REMOVE WINDOWS

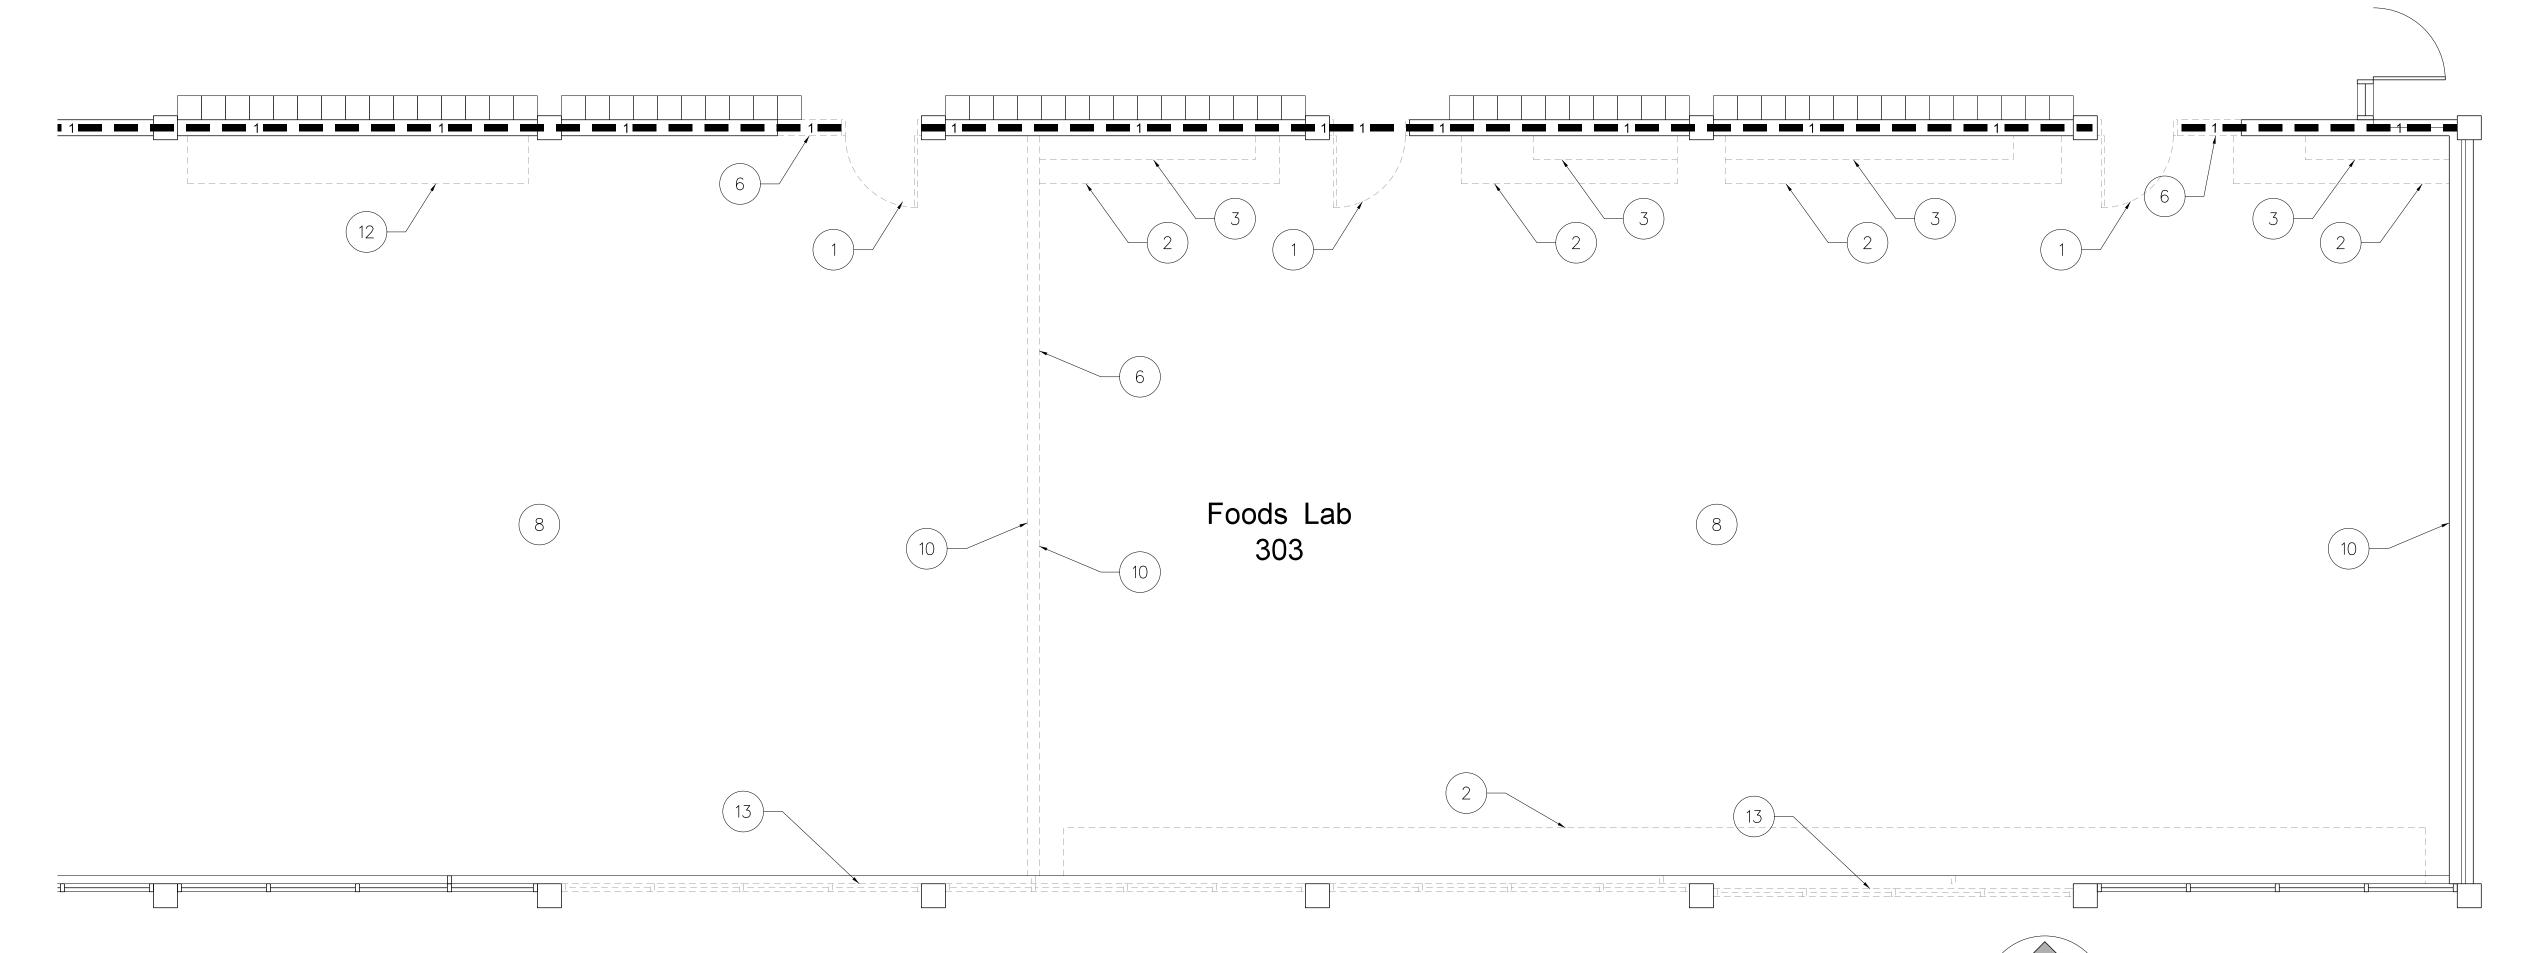

709.1 DEMOLITION PLAN SCALE: 1/4" = 1'-0"

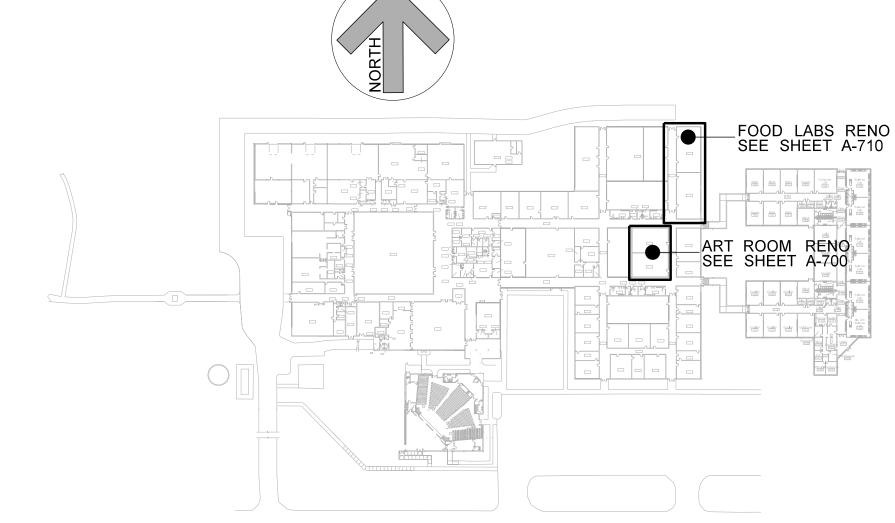

**DRAWING LEGEND** 

EXISTING CONSTRUCTION TO REMAIN

=== EXISTING CONSTRUCTION TO BE REMOVED

NOTE: ALL EXISTING DOORS, CASEWORK, AND OTHER SALVAGEABLE ITEMS TO BE REMOVED SHALL BE REMOVED WITH CARE AND TURNED OVER TO THE OWNER.

KEY PLAN

1 9/16/24 Revised per Addenc

HITE ASSOCIATES
RCHITECTURE / PLANNING / TECHNOLOGY



t Carteret High School 3263 Hwy. 70, Beaufort, NC 28516

709

MT METAL THRESHOLD W/ 1/2" MAX. LIP

RT RUBBER TRANSITION W/ 1/2" MAX. LIP

SEE SHEET T-1 FOR ADDITIONAL ABBREVIATIONS

FEC FIRE EXTINGUISHER CABINET

C.J. CONTROL JOINTE.J. EXPANSION JOINTTD TRAVEL DISTANCE

1 9/16/24 Revised per Addendum 1
No. Date: Revision

TEB 3880 GIBLES CHITECTURE / PLANNING / TECHNOLOGY



Carteret High School

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