
INDICATED ON DETAILS

(3) PROVIDE MANUFACTURER'S HOUSING w/ OSHA APPROVED MOTOR GUARD AND BACK DRAFT DAMPER.

(4) PROVIDE AND INSTALL MANUFACTURER'S ROOF CURB ADAPTER.

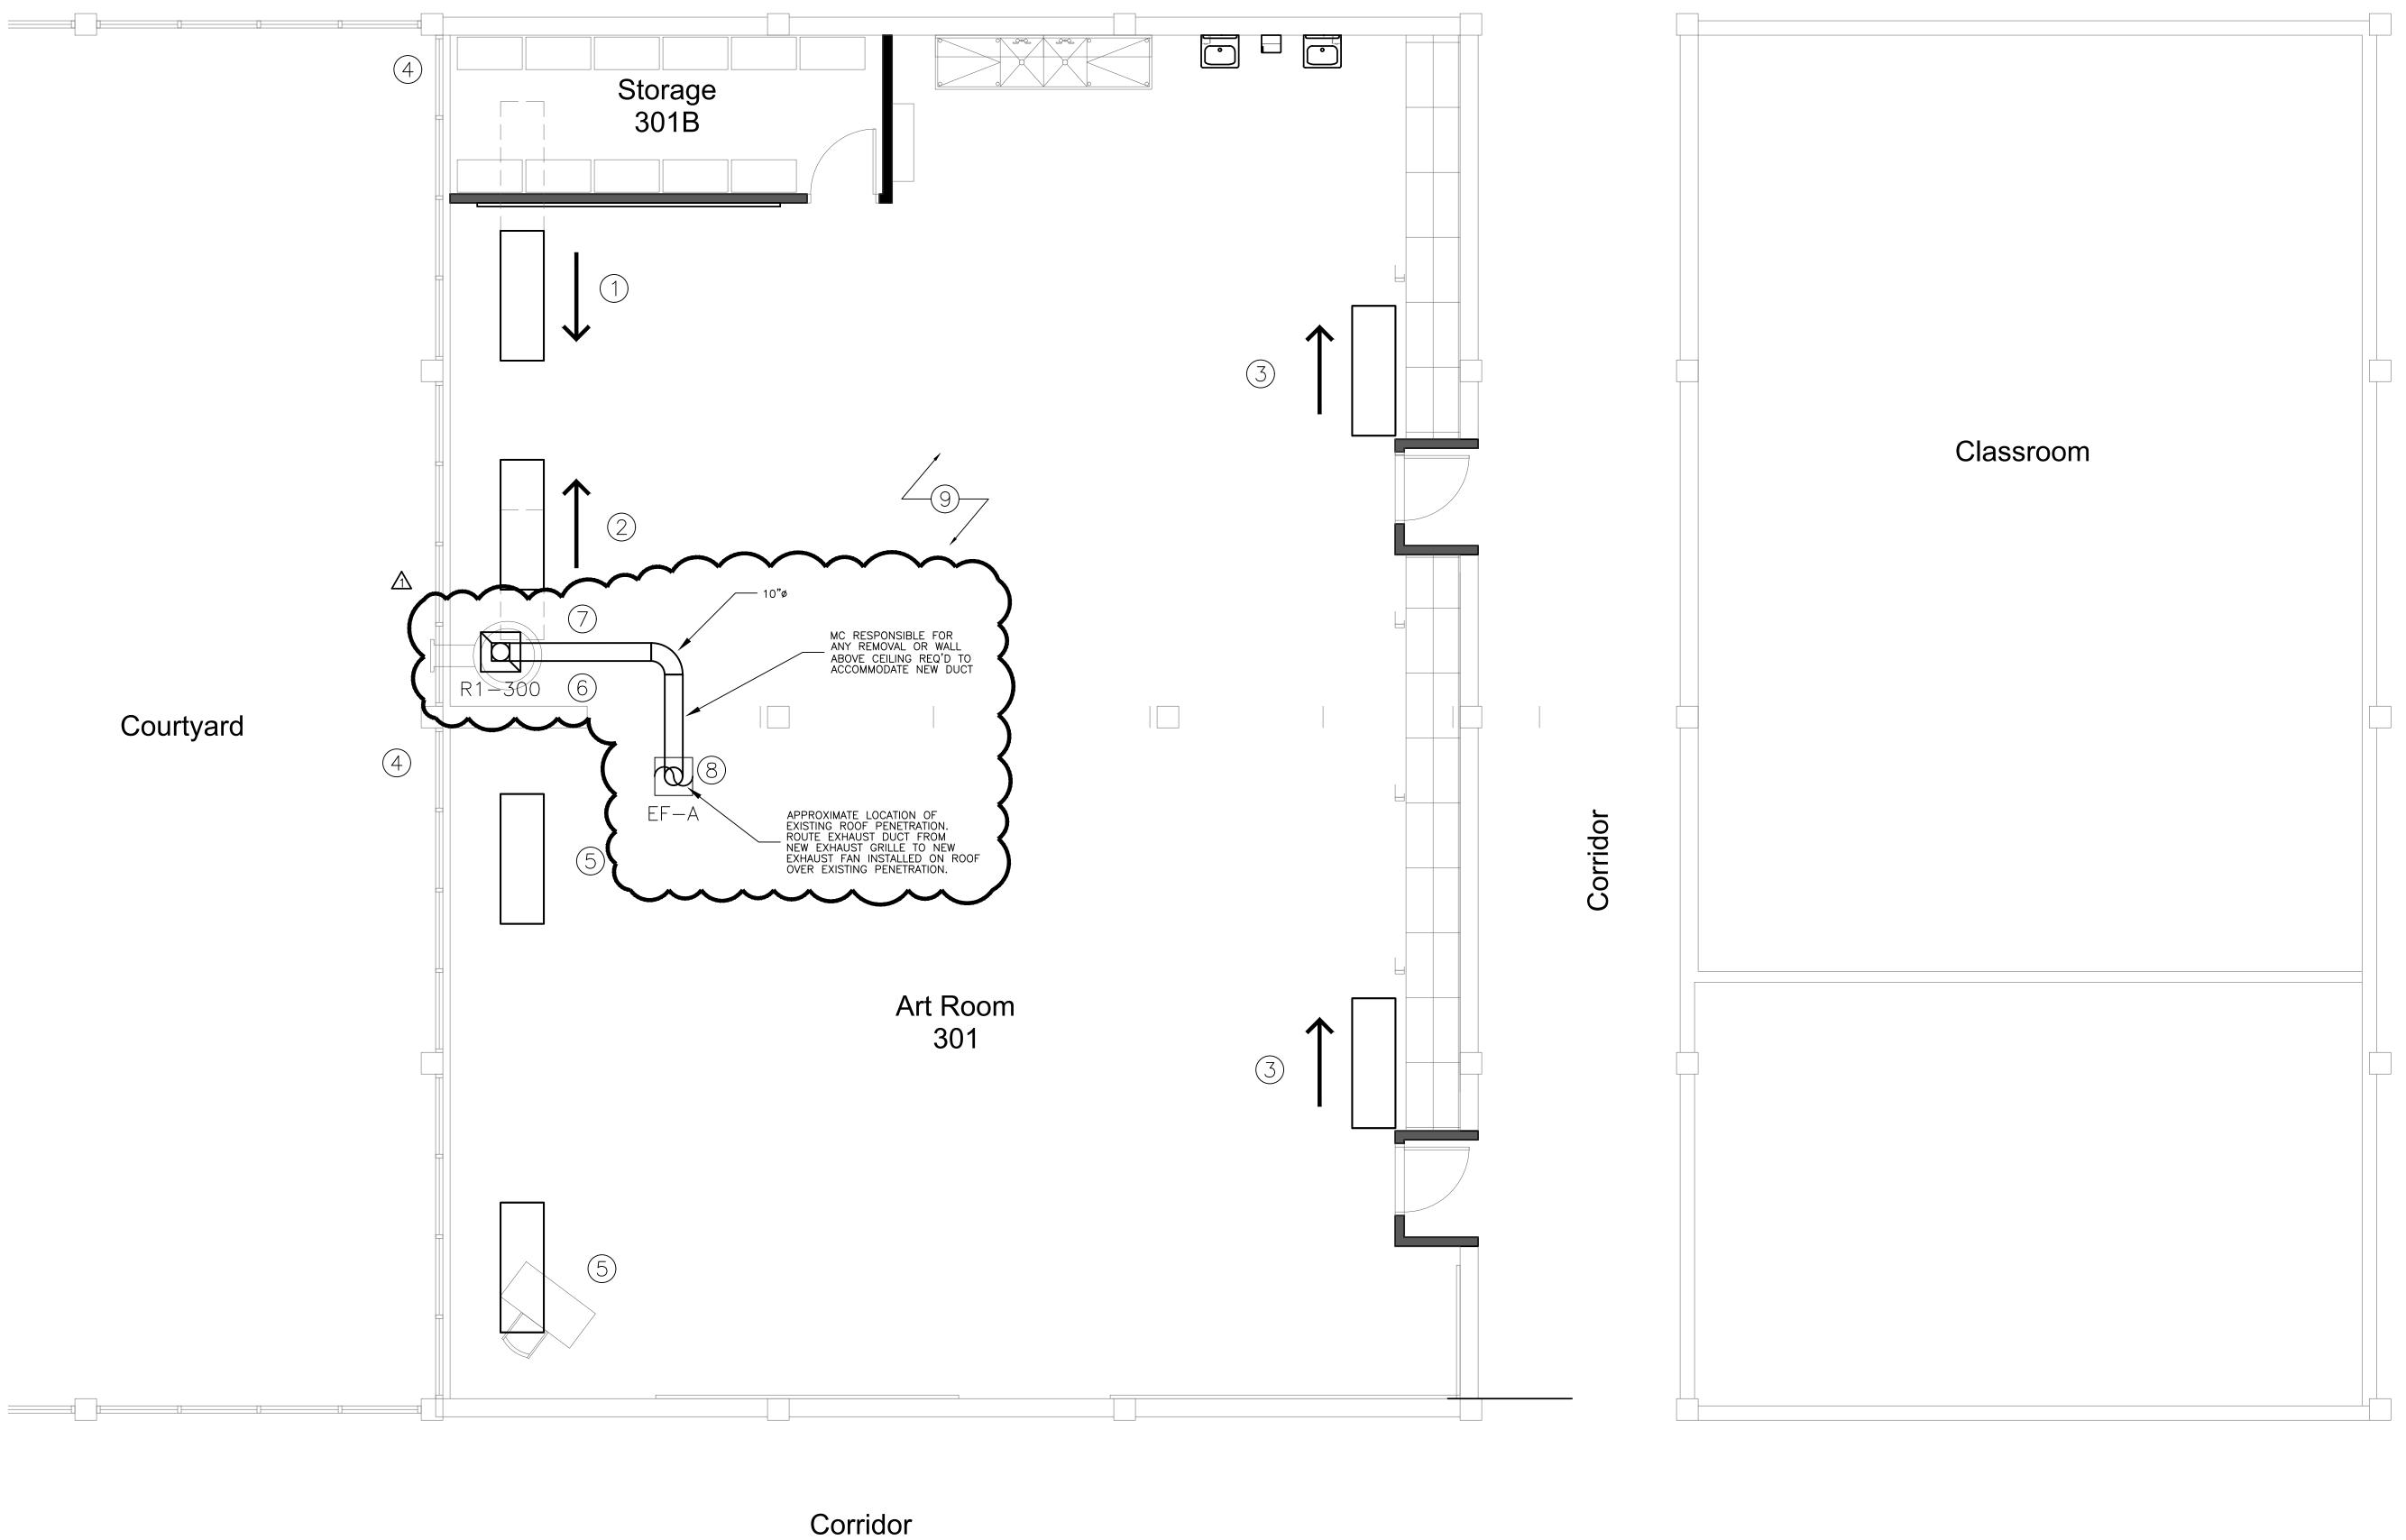

MECHANICAL PLAN NOTES:

 EXISTING FAN COIL UNIT TO BE RELOCATED TO NOT BE IN CONFLICT WITH NEW STORAGE ROOM WALL. CONTRACTOR SHALL REWORK HYDRONIC PIPING AS REQUIRED TO RECONNECT UNIT TO EXISTING HYDRONIC BRANCH PIPING. UNIT TO MOVE APPROXIMATELY 72" IN DIRECTION INDICATED. CONTRACTOR SHALL REWORK CONDENSATE PIPING TO CONNECT UNIT BACK TO EXISTING CONDENSATE DRAIN PIPING. CONTRACTOR SHALL FIELD VERIFY EXACT DIMENSIONS AND COORDINATE FINAL LOCATION WITH ALL OTHER TRADES.

(2) EXISTING FAN COIL UNIT TO BE RELOCATED TO NOT BE IN CONFLICT WITH KILN EXHAUST HOOD. CONTRACTOR SHALL REWORK HYDRONIC PIPING AS REQUIRED TO RECONNECT UNIT TO EXISTING HYDRONIC BRANCH PIPING. UNIT TO MOVE APPROXIMATELY 30" IN DIRECTION INDICATED. CONTRACTOR SHALL REWORK CONDENSATE PIPING TO CONNECT UNIT BACK TO EXISTING CONDENSATE DRAIN PIPING. CONTRACTOR SHALL FIELD VERIFY EXACT DIMENSIONS AND

COORDINATE FINAL LOCATION WITH ALL OTHER TRADES.


3 EXISTING FAN COIL UNIT TO BE RELOCATED IN THE DIRECTION INDICATED TO NOT BE IN CONFLICT WITH NEW INSET ENTRY DOOR, AS REQUIRED. CONTRACTOR SHALL REWORK HYDRONIC PIPING AS REQUIRED TO RECONNECT UNIT BACK TO EXISTING HYDRONIC BRANCH PIPING. CONTRACTOR SHALL REWORK CONDENSATE PIPING TO CONNECT UNIT BACK TO EXISTING CONDENSATE DRAIN PIPING. CONTRACTOR SHALL FIELD VERIFY EXACT DIMENSIONS AND COORDINATE FINAL LOCATION WITH ALL OTHER TRADES.

4 EXISTING EXHAUST FAN AND ASSOCIATED DUCTWORK TO BE REMOVED. CONTRACTOR TO SEAL EXTERIOR PENETRATIONS AFTER

(5) EXISTING FAN COIL UNIT TO REMAIN. (6) EXISTING KILN TO BE RELOCATED AS INDICATED. PROVIDE AND INSTALL "ENVIROVENT 2" KIT AND "ENVIROLINK" KIT FROM KILN MANUFACTURER (SKUTT) AND INSTALL WALL CAP ON BUILDING EXTERIOR BELOW EXISTING WINDOWS. CONTRACTOR SHALL FIELD VERIFY EXACT LOCATION.

(7) NEW CEILING MOUNTED EXHAUST GRILLE OVER KILN. INSTALL IN NEW ACOUSTIC TILE CEILING ABOVE KILN, AS INDICATED.
CONTRACTOR SHALL FIELD VERIFY EXACT LOCATION. ROUTE EXHAUST DUCTWORK BACK TO EXISTING ROOF PENETRATION AND CONNECT TO NEW ROOF MOUNTED EXHAUST FAN. B) EXISTING KILN EXHAUST HOOD ROOF PENETRATION. CONTRACTOR TO REMOVE EXISTING KILN HOOD AND EXHAUST FAN. INSTALL NEW ROOF MOUNTED EXHAUST FAN OVER EXISTING ROOF PENETRATION. CONTRACTOR SHALL PROVIDE NEW CURB OR MODIFY EXISTING CURB, AS REQUIRED, TO INSTALL NEW FAN.


ALL EXISTING AND NEW HVAC EQUIPMENT SHALL BE TIED BACK TO THE EXISTING CONTROLS SYSTEM. PROVIDE ANY EXPANSION CARDS, PROGRAMMING, CONTROLLER RELOCATION, UPGRADES, ETC. NECESSARY TO HAVE A COMPLETE AND OPERATIONAL SYSTEM AT PROJECT COMPLETION. CONTROLS CONTRACTOR IS RESPONSIBLE FOR FIELD VERIFYING EXISTING CONDITIONS, CONTROLLERS AND COORDINATING NEW EQUIPMENT WITH MC TO MAKE SURE IT WILL SMOOTHLY INTEGRATE INTO THE EXISTING SYSTEM.

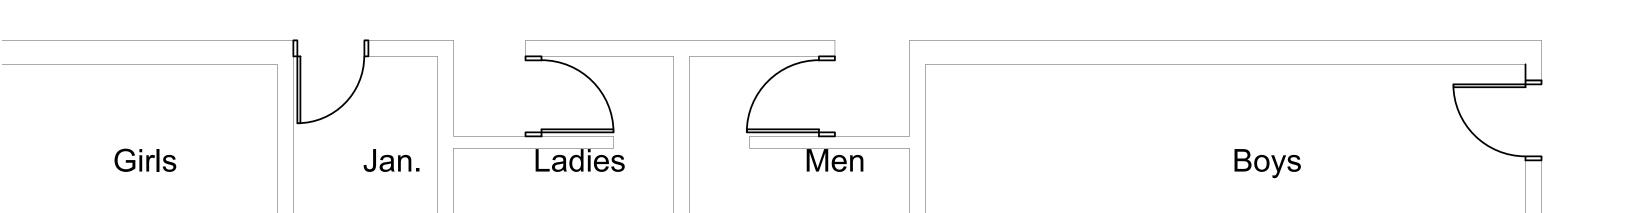

ART ROOM MECHANICAL PLAN SCALE: 1/4" = 1'-0"

EXHAUST FAN VENTILATOR SCHEDULE										
MARK CFM RPM S.P. ELECTRICAL CONTROLS								MODEL NO./DESCRIPTION	WEIGHT	NOTES
WWW.	01 W			VOLTAGE	MCA	МОСР	OOMNOLO	medical restriction from		
EF-A	300	1,045	0.250	115 V	1.9 A	15 A	LOCAL SWITCH	GREENHECK NO. CUE-090-VG DIRECT DRIVE UPBLAST CENTRIFUGAL ROOF EXHAUST FAN	30 LBS	1-4
(1) M(FAN ARE (2) FL	NOTES: (1) MODEL NUMBERS NOTED ARE GREENHECK EQUIPMENT, UNLESS OTHERWISE NOTED. EXHAUST FANS MEETING OR EXCEEDING PERFORMANCE DATA MANUFACTURED BY COOK OR CARNES ARE ACCEPTABLE SUBSTITUTES. ALL FANS SHALL HAVE UL LISTED LABELS AND OPTIONAL MOTOR COVERS. (2) FURNISH AND INSTALL MFR'S SPEED CONTROLLER OR EQUIVALENT & ALL ACCESSORIES ABBREVIATIONS: BDD: BACK DRAFT DAMPER DPST: DOUBLE POLE SINGLE THROW SWITCH BY E.C. CFM: AIR FLOW (cu ft/min) NC: NOISE CRITERIA (sones) EMS: ENERGY MANAGMENT SYSTEM									

	AIR DISTRIBUTION SCHEDULE										
MARK	MARK FACE SIZE NECK SIZE MFR/MODEL CFM/FPM NC REMARKS										
R1	24"x24"	12"x12"	PRICE/80TB	550/650	<20	LAY-IN EGG CRATE FACE RETURN WITH BLADES	@ 1/2" O.C. ALUMINUM CONSTRUCTION				
(1) A (2) K (3) P	NOTES: (1) ALL FINISHES TO BE WHITE EXCEPT WHERE NOTED. (2) KRUEGER, METAL*AIRE, TUTTLE & BAILEY, TITUS & CARNES ARE CONSIDERED EQUIVALENTS. (3) PROVIDE SQUARE TO ROUND TRANSITIONS WHERE REQUIRED. (4) VALUES LISTED ARE MAXIMUM VALUES. ABBREVIATIONS: BDD: BACK DRAFT DAMPER OBD: OPPOSED BLADE DAMPER FPM: VELOCITY (ft/min) NC: NOISE CRITERIA										

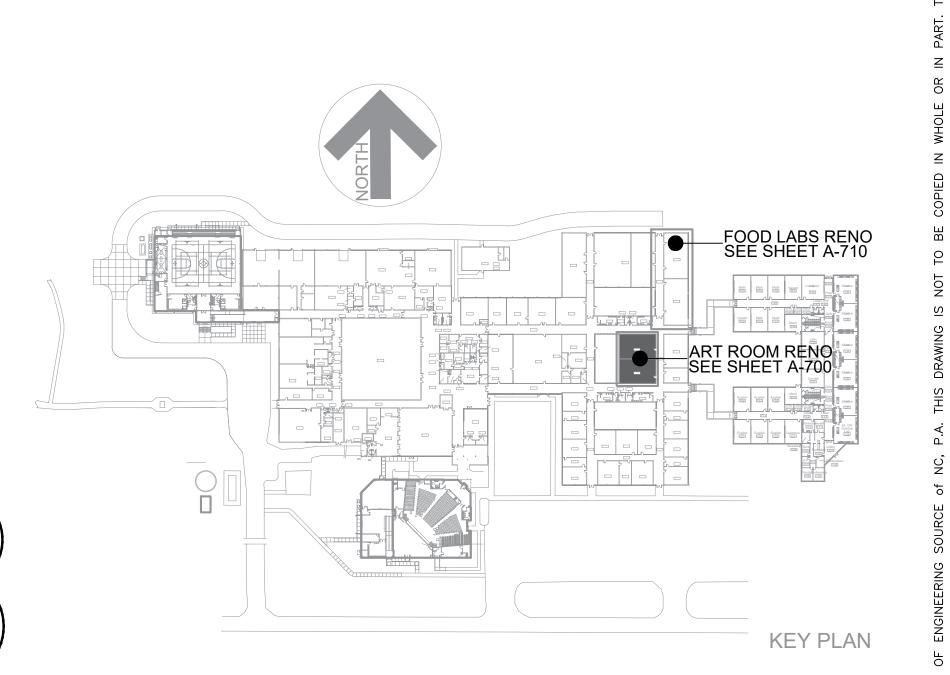


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School Room Ke

Project No. 22111

26 AUGUST, 2024

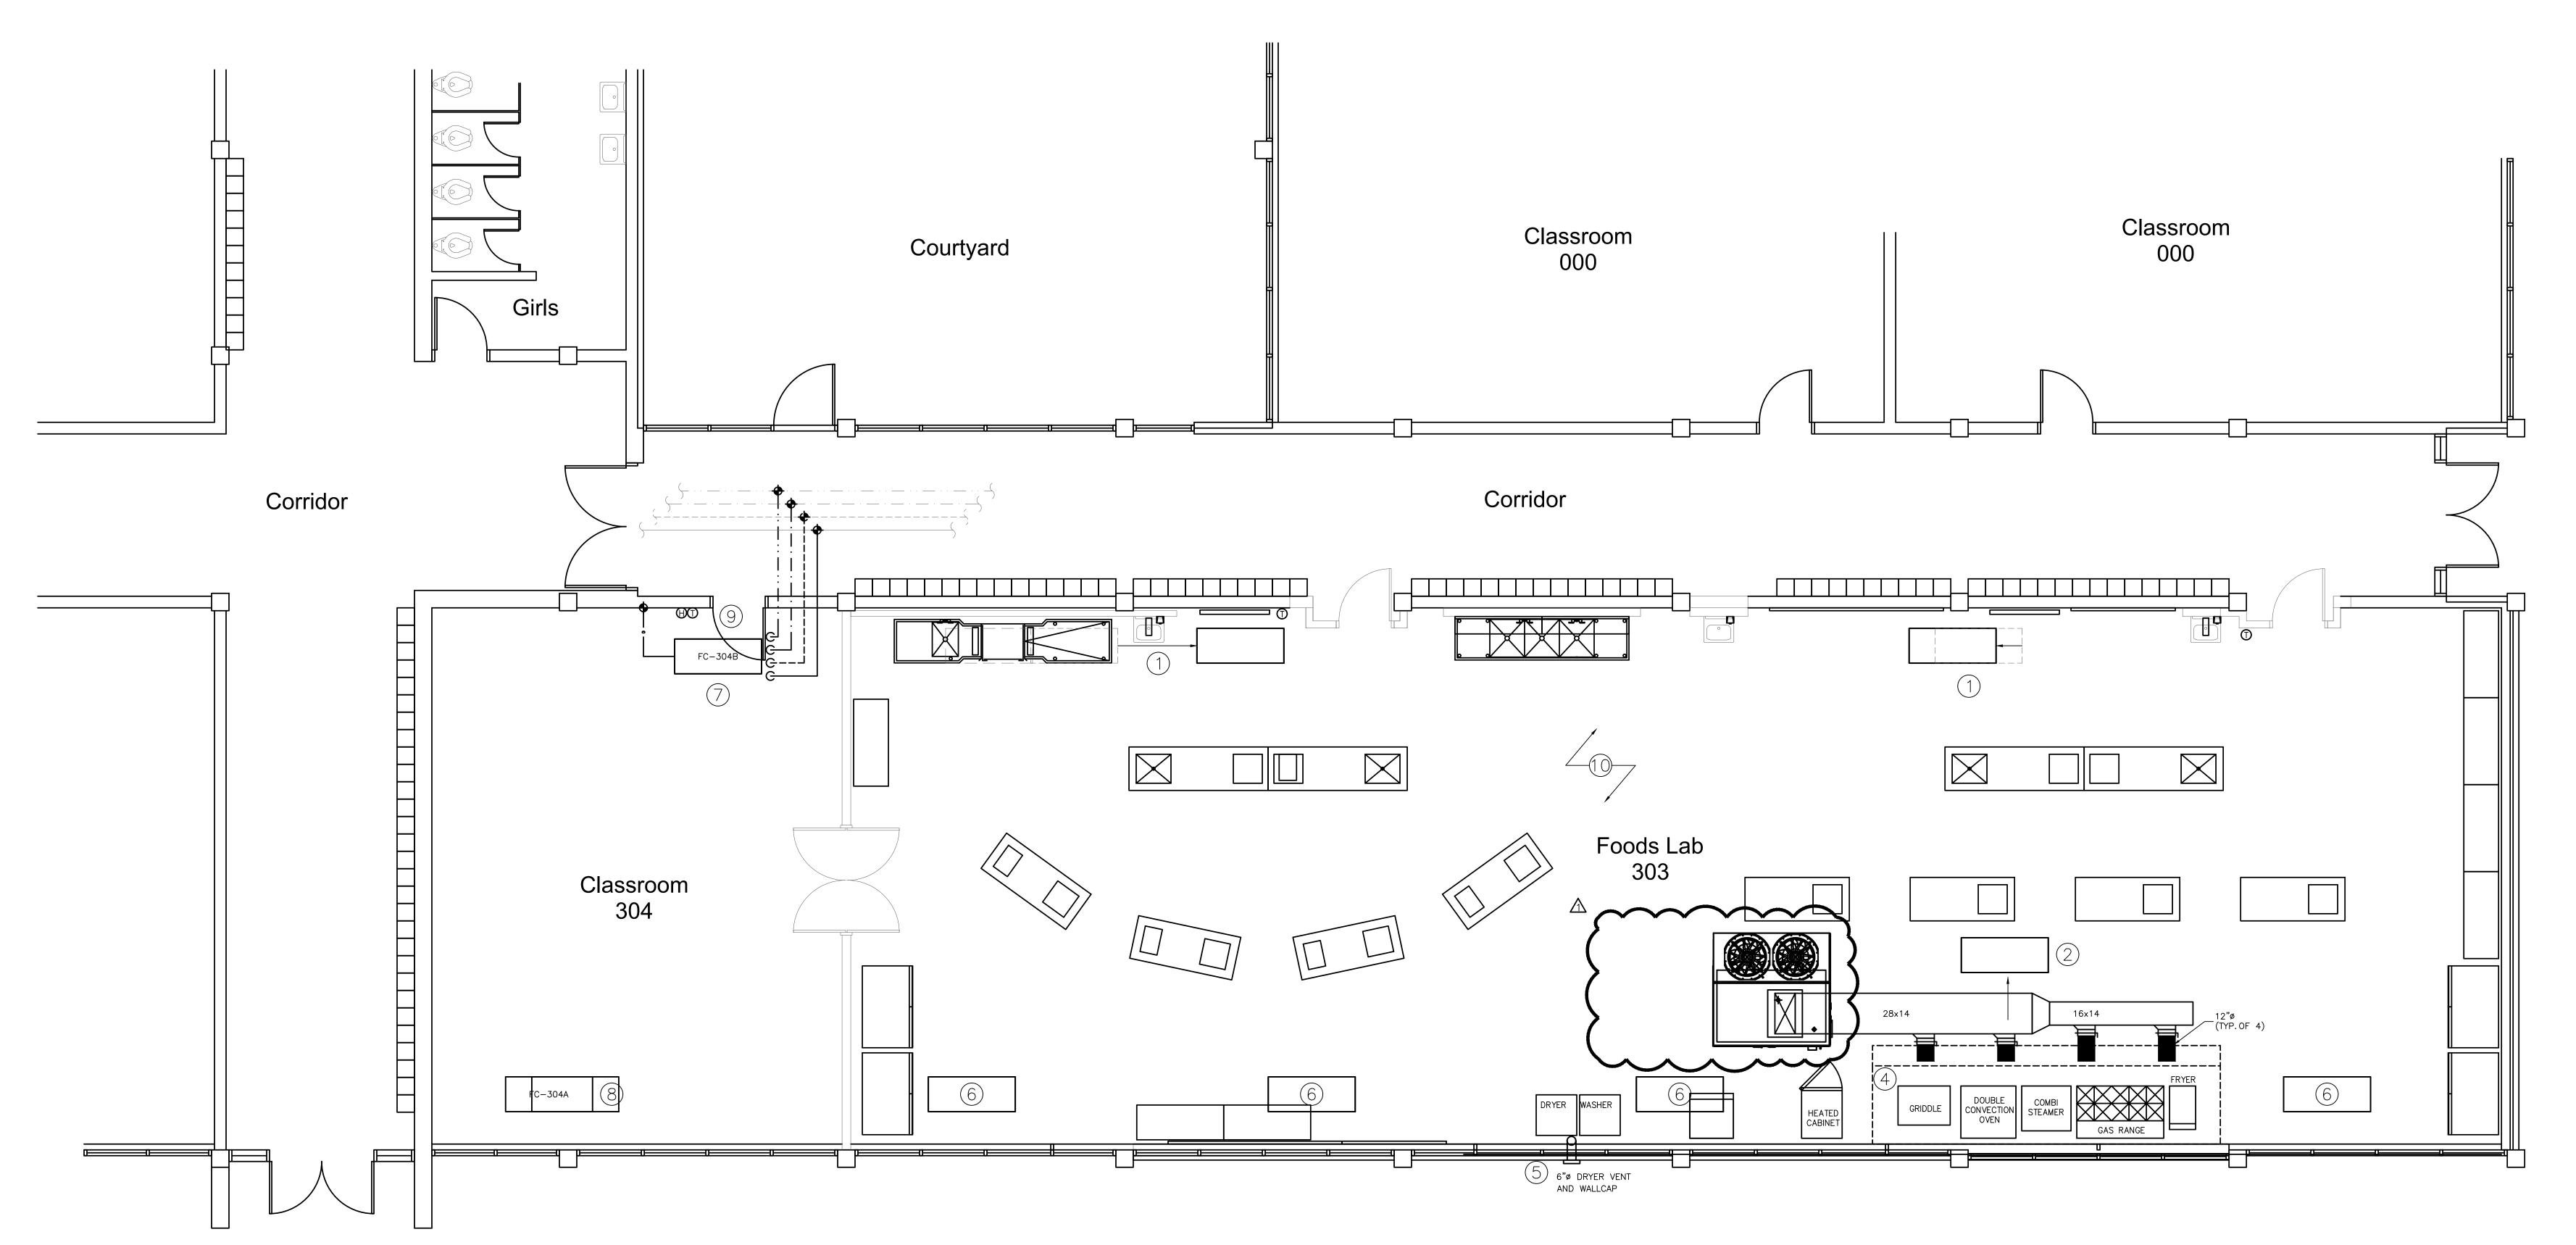

MECHANICAL PLAN NOTES:

(1) EXISTING FAN COIL UNIT RELOCATED TO NOT BE IN CONFLICT WITH NEW DISHWASHER OR LIGHTS. CONTRACTOR SHALL REWORK HYDRONIC PIPING AND CONDENSATE PIPING AS REQUIRED TO RECONNECT UNIT TO EXISTING HYDRONIC BRANCH PIPING AND EXISTING CONDENSATE DRAIN PIPING. FIELD COORDINATE EXACT LOCATION WITH EQUIPMENT AND LIGHTS. COORDINATE LOCATION WITH ALL OTHER TRADES.

② EXISTING FAN COIL UNIT ELOCATED TO NOT BE IN CONFLICT WITH NEW FOODS LAB HOOD. CONTRACTOR SHALL REWORK HYDRONIC PIPING AS REQUIRED TO RECONNECT UNIT TO EXISTING HYDRONIC BRANCH PIPING. UNIT TO MOVE APPROXIMATELY 96" IN DIRECTION INDICATED. CONTRACTOR SHALL FIELD VERIFY EXACT DIMENSIONS AND COORDINATE FINAL LOCATION WITH ALL OTHER TRADES.

- (3) TURN DUCTWORK UP TO MAKE-UP AIR UNIT ON ROOF ABOVE. (4) NEW KITCHEN HOOD EXHAUST FANS MOUNTED ON ROOF ABOVE.
- (5) INSTALL NEW DRYER DUCT AND MANUFACTURER'S WALLCAP IN EXTERIOR WALL BELOW WINDOWS. 6 EXISTING FAN COIL TO REMAIN.
- 7 NEW FAN COIL. CONTRACTOR TO INSTALL IN NEW CLASSROOM AS INDICATED AND CONNECT NEW HOT AND CHILLED WATER BRANCH PIPING BACK TO PIPING MAINS. PROVIDE AND INSTALL NEW MODULATING HOT AND CHILLED WATER CONTROL VALVES AND CONNECT TO EXISTING CONTROL SYSTEM. SEE FAN COIL EQUIPMENT
- (8) REMOVE EXISTING FAN COIL AND REPLACE WITH NEW FAN COIL AND NEW CHILLED AND HOT WATER VALVES AS INDICATED IN THE FAN COIL EQUIPMENT SCHEDULE. COORDINATE LOCATION WITH LIGHTS. REWORK TRIM PIPING TO CONNECT BACK TO EXISTING CHILLED AND HOT WATER PIPING.
- PROVIDE AND INSTALL NEW TEMP—SENSOR AND HUMIDISTAT (CAN BE A COMBINATION UNIT) MOUNTED ON WALL NEAR CLASSROOM DOOR. CONNECT FC-304A AND FC-304B TO NEW SENSOR. TIE BACK TO EXISTING JOHNSON CONTROL SYSTEM.
- ALL EXISTING AND NEW HVAC EQUIPMENT SHALL BE TIED BACK TO
 THE EXISTING CONTROLS SYSTEM. PROVIDE ANY EXPANSION CARDS, PROGRAMMING, CONTROLLER RELOCATION, UPGRADES, ETC. NECESSARY TO HAVE A COMPLETE AND OPERATIONAL SYSTEM AT PROJECT COMPLETION. CONTROLS CONTRACTOR IS RESPONSIBLE FOR FIELD VERIFYING EXISTING CONDITIONS, CONTROLLERS AND COORDINATING NEW EQUIPMENT WITH MC TO MAKE SURE IT WILL SMOOTHLY INTEGRATE INTO THE EXISTING SYSTEM.

FOOD LAB MECHANICAL PLAN SCALE: 1/4" = 1'-0"

MECHANICAL LEGEND G.C. GEN. CONTR.

E.C. ELEC. CONTR. P.C. PLUMB. CONTR. ABOVE FINISH FLOOR ABOVE FINISH GRADE WRAPPED RIGID DUCT

INSULATED FLEXIBLE DUCT SUPPLY DIFFUSER RETURN AIR GRILLE CEILING EXHAUST GRILLE OR FAN

THERMOSTAT & UNIT SERVED. HUMIDISTAT & UNIT SERVED. DIFFUSER TYPE-CFM

MANUAL DAMPER DUCT MOUNTED SMOKE DETECTOR


CEILING MOUNTED SMOKE DETECTOR FIRE ALARM HORN/STROBE (SEE GENERAL NOTES)


CONN. TO EXIST. GAS PIPING


SPRING LOADED FIRE DAMPER CAHU-1 CO2 SENSOR (800 PPM)

TWIST TIMER SWITCH 120V MOTORIZED DAMPER

OAHU-1 CO SENSOR & UNIT SERVED. CNAHU-1 CO & NO SENSOR & UNIT SERVED.

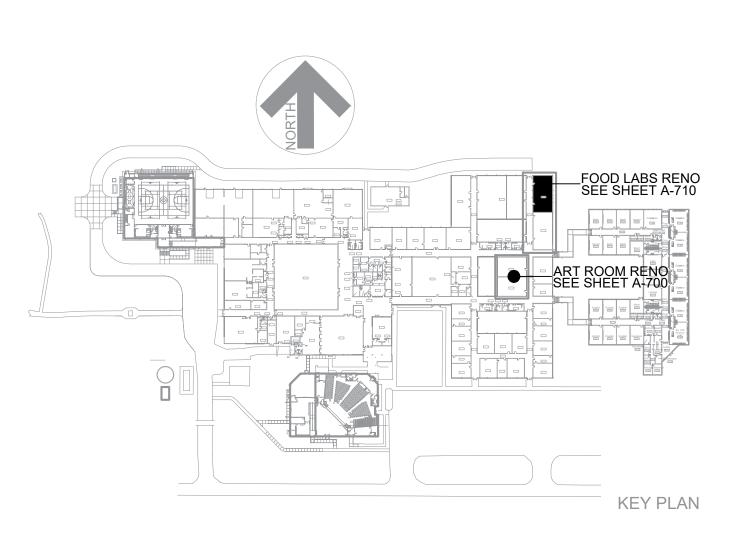

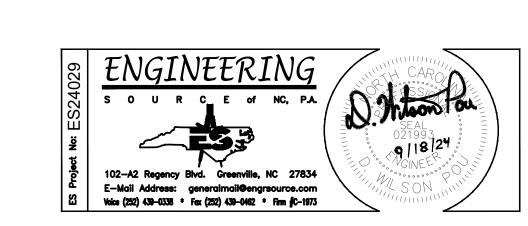


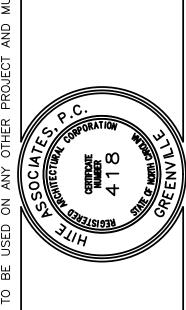

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Project No. 22111

26 AUGUST, 2024

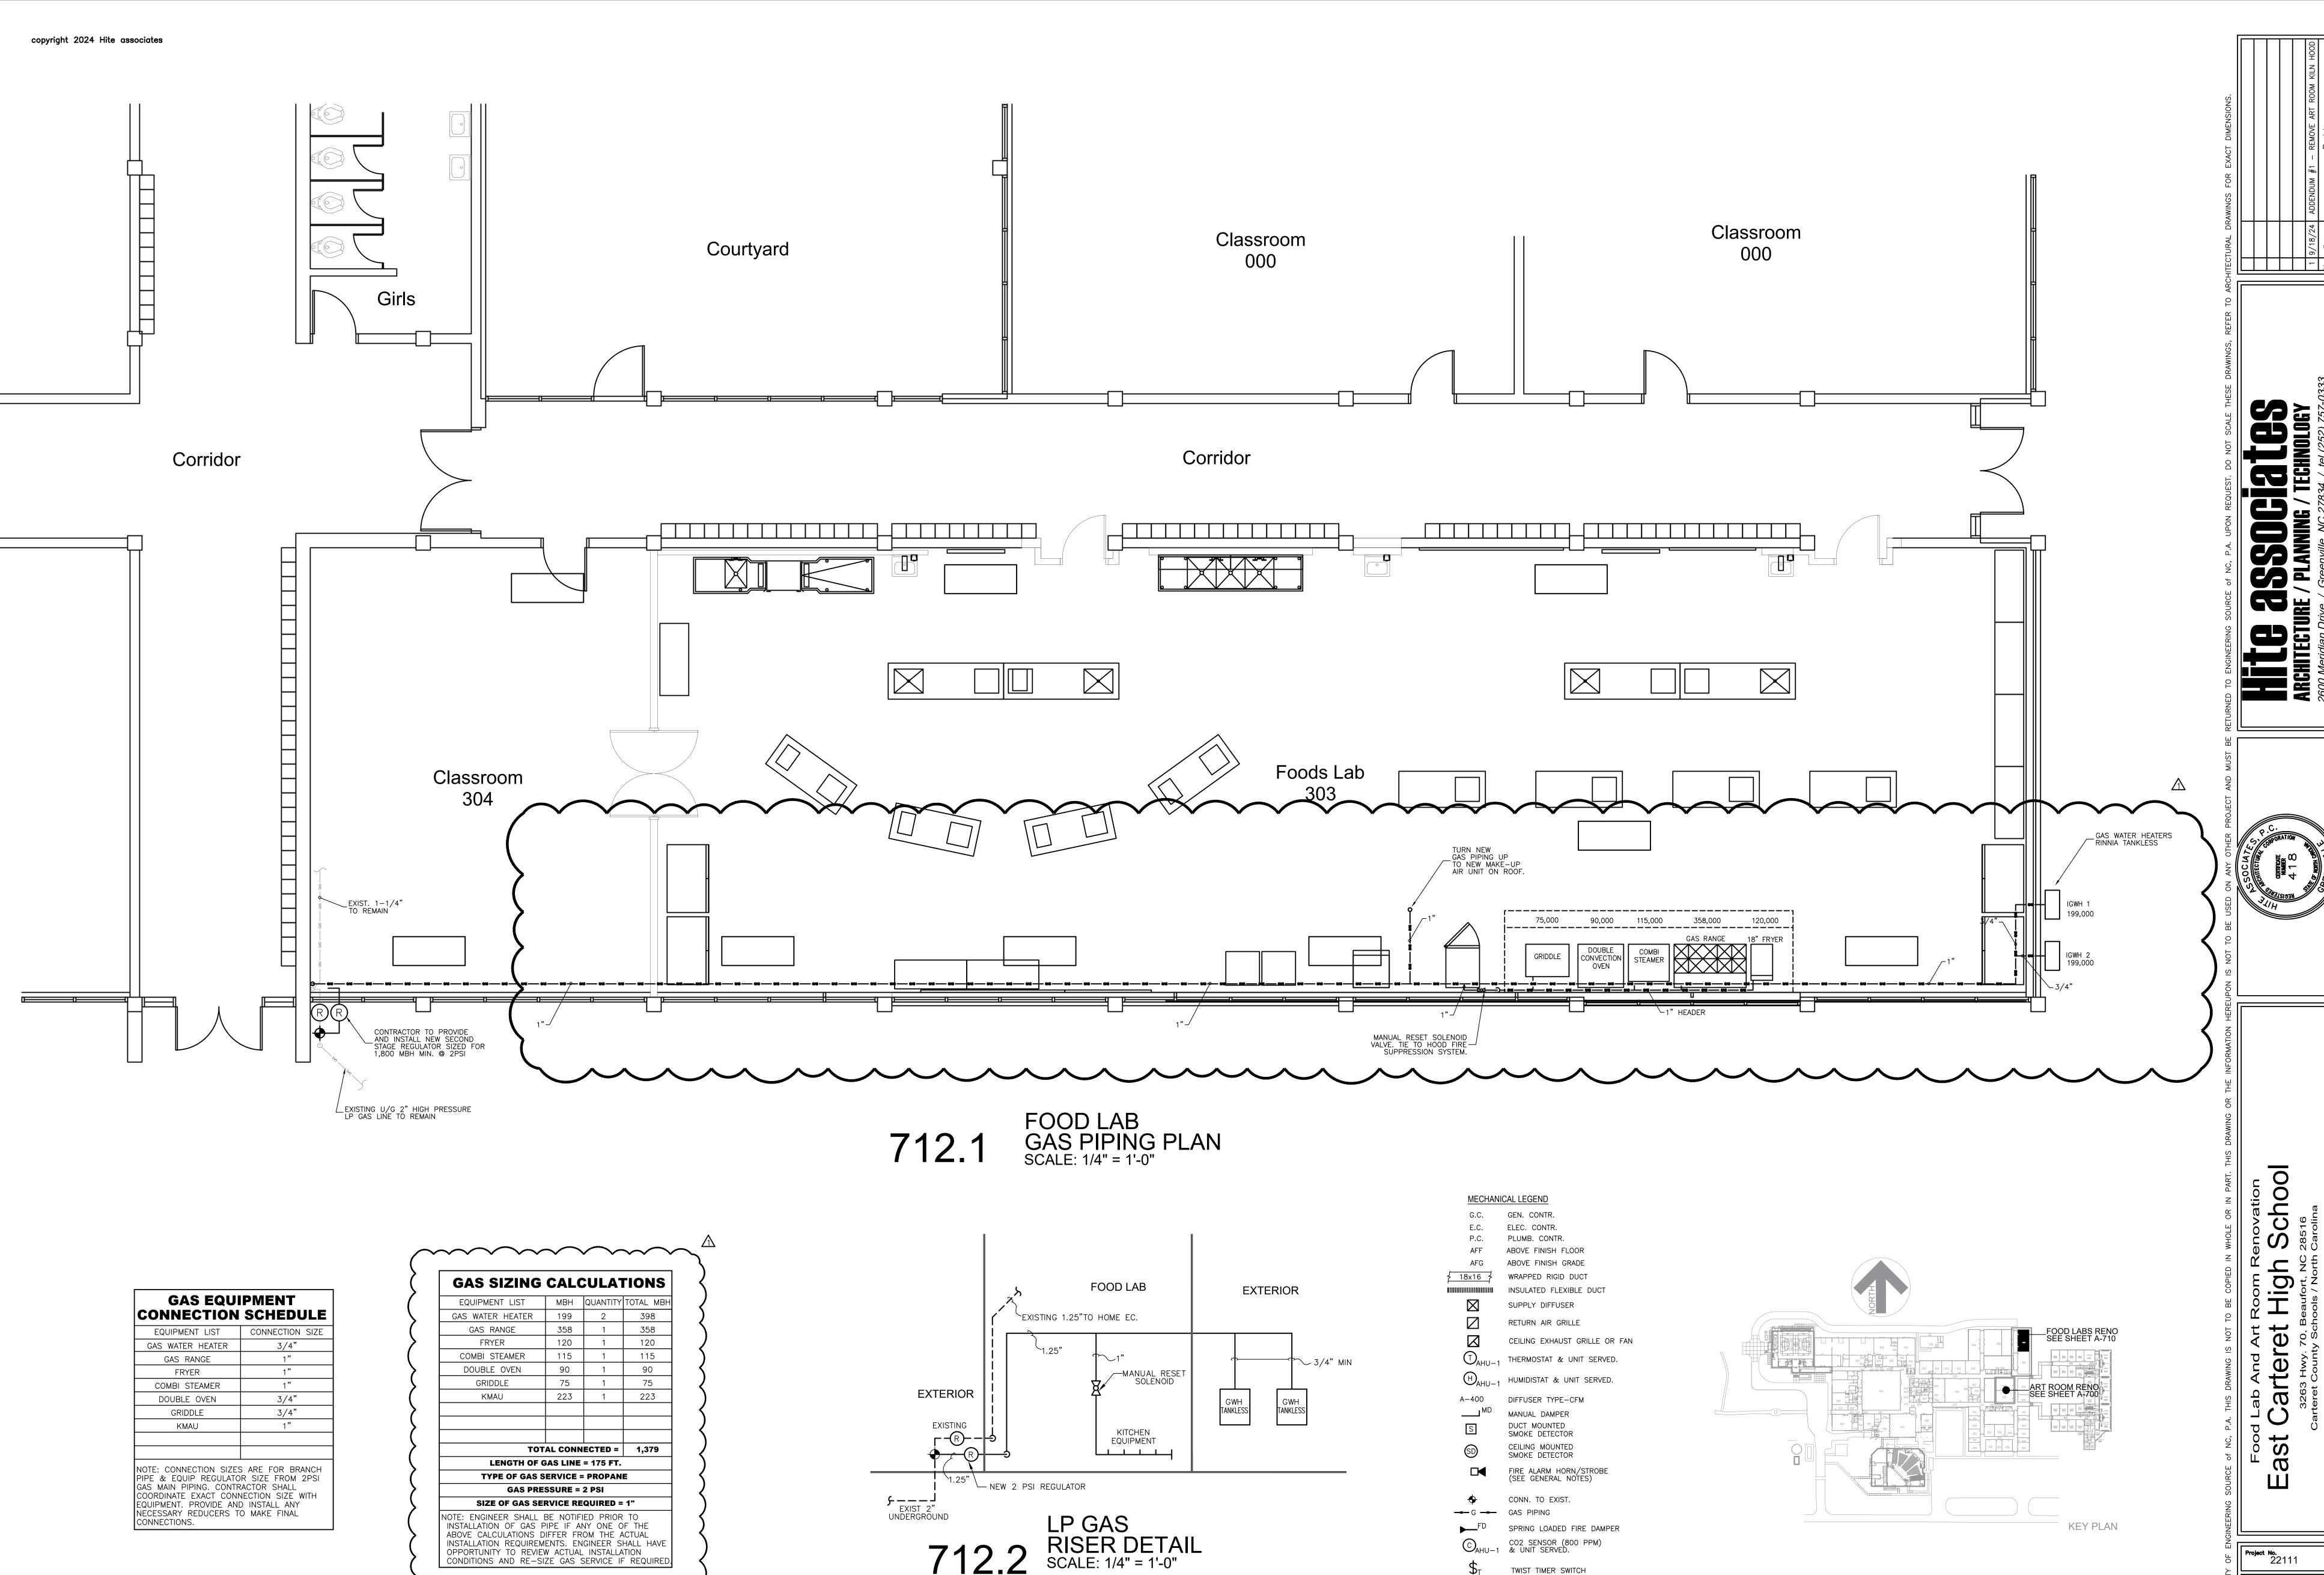

120V MOTORIZED DAMPER

CNAHU-1 CO & NO SENSOR & UNIT SERVED.

OAHU-1 CO SENSOR & UNIT SERVED.

Project No. 22111

Date: 26 AUGUST, 2024

Drawing no. 712

ENGINEERING

E-Mail Address: generalmail@engrsource.com Voice (252) 439-0338 * Fax (252) 439-0462 * Firm (C-1973 FOR QUESTIONS, CALL THE

Eastern North Carolina

REGION 36

PHONE: (919) 825 - 3566

EMAIL: reg36@captiveaire.com

PATENT NUMBERS

AC-PSP (UNITED STATES) - US PATENT 7963830 B2.
AC-PSP WALL (CANADA) - CA PATENT 2820509.
AC-PSP ISLAND (CANADA) - CA PATENT 2520330.

HOOD INFORMATION - JOB#7048750

<u>поо</u>	<u>D INF</u>	<u>URMATIUN</u>	<u> </u>	<u> </u>																
		MODEL	•	LENGTH	MAX COOKING TEMP	TYPE		DESIGN					UST PL				TOTAL		HOOD CONFIG	
HOOD NO	TAG		MANUFACTURER					DESIGN	TOTAL EXH CFM	RISER(S)							SUPPLY	HOOD	END TO	
	1/40		MAINOLAGIGICER					CFM/FT		WIDTH	LENG	HEIGHT	DIA	CFM	VEL	SP	CFM	CONSTRUCTION	END	ROW
	+	5424																470.00		-
1	KH-1	5424 ND-2-PSP-F	F CAPTIVEAIRE	10' 0"	600 DEG	I	HEAVY	200	2000				14"	2000	1871	1.068	1600	430 SS	LEFT .	ALONE
												•	• •				''	WHERE EXPOSED		' ''
	T	-2 5424 ND-2-PSP-F	24		600	•	HEAVY	200	2000			4"	14"	2000	1871	-1.068"	1600	430 SS		
2	KH-2		CAPTIVEAIRE	10'0"	DEG	ı												WHERE EXPOSED	RIGHT A	ALONE
		110 2 101 1																THILLIAL EXITOGED		

		ND-2-PSP-F			DEG				•	,,	1000	Wh	HERE EXPOSED					EFFIC
HOOL) INF	ORMATION																_
		FILTER(S)					LIGHT(S)			UTILITY CABINET(S)							HOOD	1
HOOD	TAG					EFFICIENCY @ 7			WIDE			FII	RE SYSTEM	ELECTRICAL	SWITCHES	FIRE	HANGING	8
HOOD NO	170	TYPE	QTY HEIGHT LENGTH		MICRONS	QTY	Y TYPE	WIRE GUARD	LOCATION	SIZE	TYPE	SIZE	MODEL #	QUANTITY	PIPING		CY (%)	
1	KH-1	CAPTRATE SOLO FILTER	7	16"	16"	85% SEE FILTER SPEC	5	RECESSED ROUND	NO							YES	590 LBS	L EFFICIEN
2	KH-2	CAPTRATE SOLO FILTER	7	16"	16"	85% SEE FILTER SPEC	5	RECESSED ROUND	NO	RIGHT	12"x54"x24"	TANK FS	4.0/4.0/4.0			YES	975 LBS	ACTIONA

HOOD OPTIONS

HOOD NO	TAG	OPTION
	KH-1	FIELD WRAPPER 18.00" HIGH FRONT, LEFT.
,		BACKSPLASH 80.00" HIGH X 252.00" LONG 430 SS VERTICAL.
'		LEFT QUARTER END PANEL 23" TOP WIDTH, 0" BOTTOM WIDTH, 23" HIGH 430 SS.
		INSULATION FOR BACK OF HOOD.
		FIELD WRAPPER 18.00" HIGH FRONT, RIGHT.
2	KH-2	RIGHT QUARTER END PANEL 23" TOP WIDTH, 0" BOTTOM WIDTH, 23" HIGH 430 SS.
		INSULATION FOR BACK OF HOOD.

PERFORATED SUPPLY PLENUM(S)

	<u>PLRF</u>	UKAII	<u>אטט עצ</u>	<u>PLI I</u>	<u>LLINU</u>	M(O)								
	HOOD							RISER(S)						
	HOOD NO	TAG	POS	LENGTH	WIDTH	HEIGHT	TYPE	WIDTH	LENG	DIA	CFM	SP		
		KH-1	Front	120"	14"	6"	MUA	12"	28"		800	0.206"		
	•	KH-I	Front				MUA	12"	28"		800	0.206"		
	2	KH-2	Front	132"	14"	6"	MUA	12"	28"		800	0.191"		
		Kn-2	FION	132			MUA	12"	28"		800	0.191"		

2 KH-2 Front 132" 14" 6" MUA 12" 28" 800 0.191"

GREASE DUCT & CHIMNEY SPECIFICATIONS:
PROVIDE GREASE DUCT EQUAL TO CAPTIVEAIRE SYSTEMS MODEL "DW"
ROUND 20 GAUGE 430 STAINLESS STEEL DUCTWORK. MODEL "DW"

CONNECTIONS SEALED WITH 3M FIRE BARRIER 2000 PLUS. MODEL "DW"
DOES NOT REQUIRE WELDING PROVIDING IT HAS BEEN INSTALLED PER
THE MANUFACTURES INSTALLATION GUIDE.
PROVIDE RATED ACCESS DOORS AT EVERY CHANGE IN DIRECTION AND EVERY 12' ON CENTER. PER
MANUFACTURES LISTING MODEL "DW" HORIZONTAL RUNS LESS THAN 75 FT. CAN BE SLOPED 1/16"

IS LISTED TO UL-1978 AND IS INSTALLED USING "V" CLAMP LOCKING

MANUFACTURES LISTING MODEL "DW" HORIZONTAL RUNS LESS THAN 75 FT. CAN BE SLOPED 1/16"
PER 12", HORIZONTAL RUNS MORE THAN 75 FT. CAN BE SLOPED 3/16" PER 12".
DUCT SHOULD BE SLOPED AS MUCH AS POSSIBLE TO REDUCE THE CHANCE OF GREASE
ACCUMULATION IN HORIZONTAL RUNS.

IF THE DUCT OR CHIMNEY IS WITHIN 18 INCHES OF COMBUSTIBLE MATERIAL, PROVIDE UL-2221 OR UL-103 HT LISTED DOUBLE WALL GREASE DUCT OR DOUBLE WALL CHIMNEY EQUAL TO CAPTIVEAIRE SYSTEMS MODEL "DW- 2R, 2R TYPE HT, 3R, OR 3Z" ROUND 20 GAUGE 430 STAINLESS INNER DUCT INSULATED WITH A 24 CAUGE 430 STAINLESS OUTER SHELL.

CAPTIVEAIRE SYSTEMS RECOMMENDS THE USE OF LISTED, PRE-FABRICATED ROUND GREASE EXHAUST DUCT TO REDUCE STATIC PRESSURE IN THE SYSTEM, MINIMIZE INSTALLATION AND INSPECTION TIMES, AND ENSURE DUCT IS LIQUID TIGHT

HVAC DISTRIBUTION NOTE

HIGH VELOCITY DIFFUSERS OR HVAC RETURNS
SHOULD NOT BE PLACED WITHIN TEN (10) FEET
OF THE EXHAUST HOOD. PERFORATED DIFFUSERS
ARE RECOMMENDED.

VERIFY CEILING HEIGHT

___' - ___'

HEIGHT REQUIRED TO VERIFY THAT HOOD FITS SPACE AND TO SIZE THE ENCLOSURE PANELS

CUSTOMER APPROVAL TO MANUFACTURE:

APPROVED AS NOTED	
APPROVED WITH NO EXCEPTION TAKEN	
REVISE AND RESUBMIT	
SIGNATURE	

NOTE: ALL INFORMATION AND DETAILS ON THIS SHEET WERE TAKEN FROM DRAWINGS PROVIDED BY CAPTIVE AIRE.


SPECIFICATION: CAPTRATE GREASE—STOP SOLO FILTER

THE CAPTRATE GREASE—STOP SOLO FILTER IS A SINGLE—STAGE FILTER FEATURING A UNIQUE S—BAFFLE DESIGN IN CONJUNCTION WITH A SLOTTED REAR BAFFLE DESIGN, TO DELIVER EXCEPTIONAL FILTRATION EFFICIENCY.

FILTER IS STAINLESS STEEL CONSTRUCTION, AND SIZED TO FIT INTO STANDARD 2—INCH DEEP HOOD CHANNEL(S).

UNITS SHALL INCLUDE STAINLESS STEEL HANDLES AND A FASTENING DEVICE TO SECURE THE TWO COMPONENTS WHEN ASSEMBLED.

GREASE EXTRACTION EFFICIENCY PERFORMANCE SHALL REMOVE AT LEAST 75% OF GREASE PARTICLES FIVE MICRONS IN SIZE, AND 85% GREASE PARTICLES SEVEN MICRONS IN SIZE AND LARGER, WITH A CORRESPONDING PRESSURE DROP NOT TO EXCEED 1.0 INCHES OF WATER GAUGE. THE CAPTRATE GREASE—STOP SOLO WAS TESTED TO ASTM STANDARD ASTM F2519—05. MANUFACTURER APPROVED FOR USE IN SOLID FUEL APPLICATIONS AS A SPARK ARRESTER.

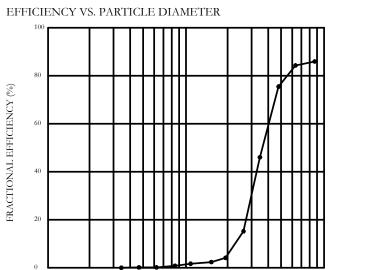

3.50
3.00
2.50
1.50
1.50
0.00
0 500 1000 1
FLOW RATE (CFM)

PRESSURE DROP VS. FLOW RATE


CAPTRATE FILTERS ARE BUILT IN COMPLIANCE WITH:. NFPA #96.
NSF STANDARD #2.
UL STANDARD #1046.
INT. MECH. CODE (IMC).

ULC-S649.

PARTICLE DIAMETER (UM)



HITE SOURCE of NC, P.A. UPON REQUEST. DO NOT SCALE REHITECTURE / PLANNING / TECHNOLOGY 2600 Meridian Drive / Greenville, NC 27834 / tel (252) 75

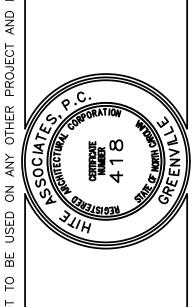

d Lab And Art Room Renovation

Carteret County Schools / North Carolina

Project No. 22111

Date: 26 AUGUST,

Date:
26 AUGUST, 2024


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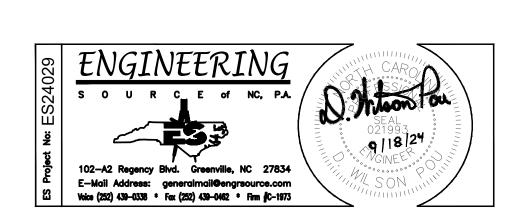
ENGINEERING

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ARCHITECTURAL DRAWINGS FOR EXACT DIMENSIONS.

1 9/18/24 ADDENDUM #1 - REMOVE ART ROOM KILN

ITE 3800 JEENNOLOGY SCHILLE PLANNING / TECHNOLOGY

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d Lab And Art Room Renovation

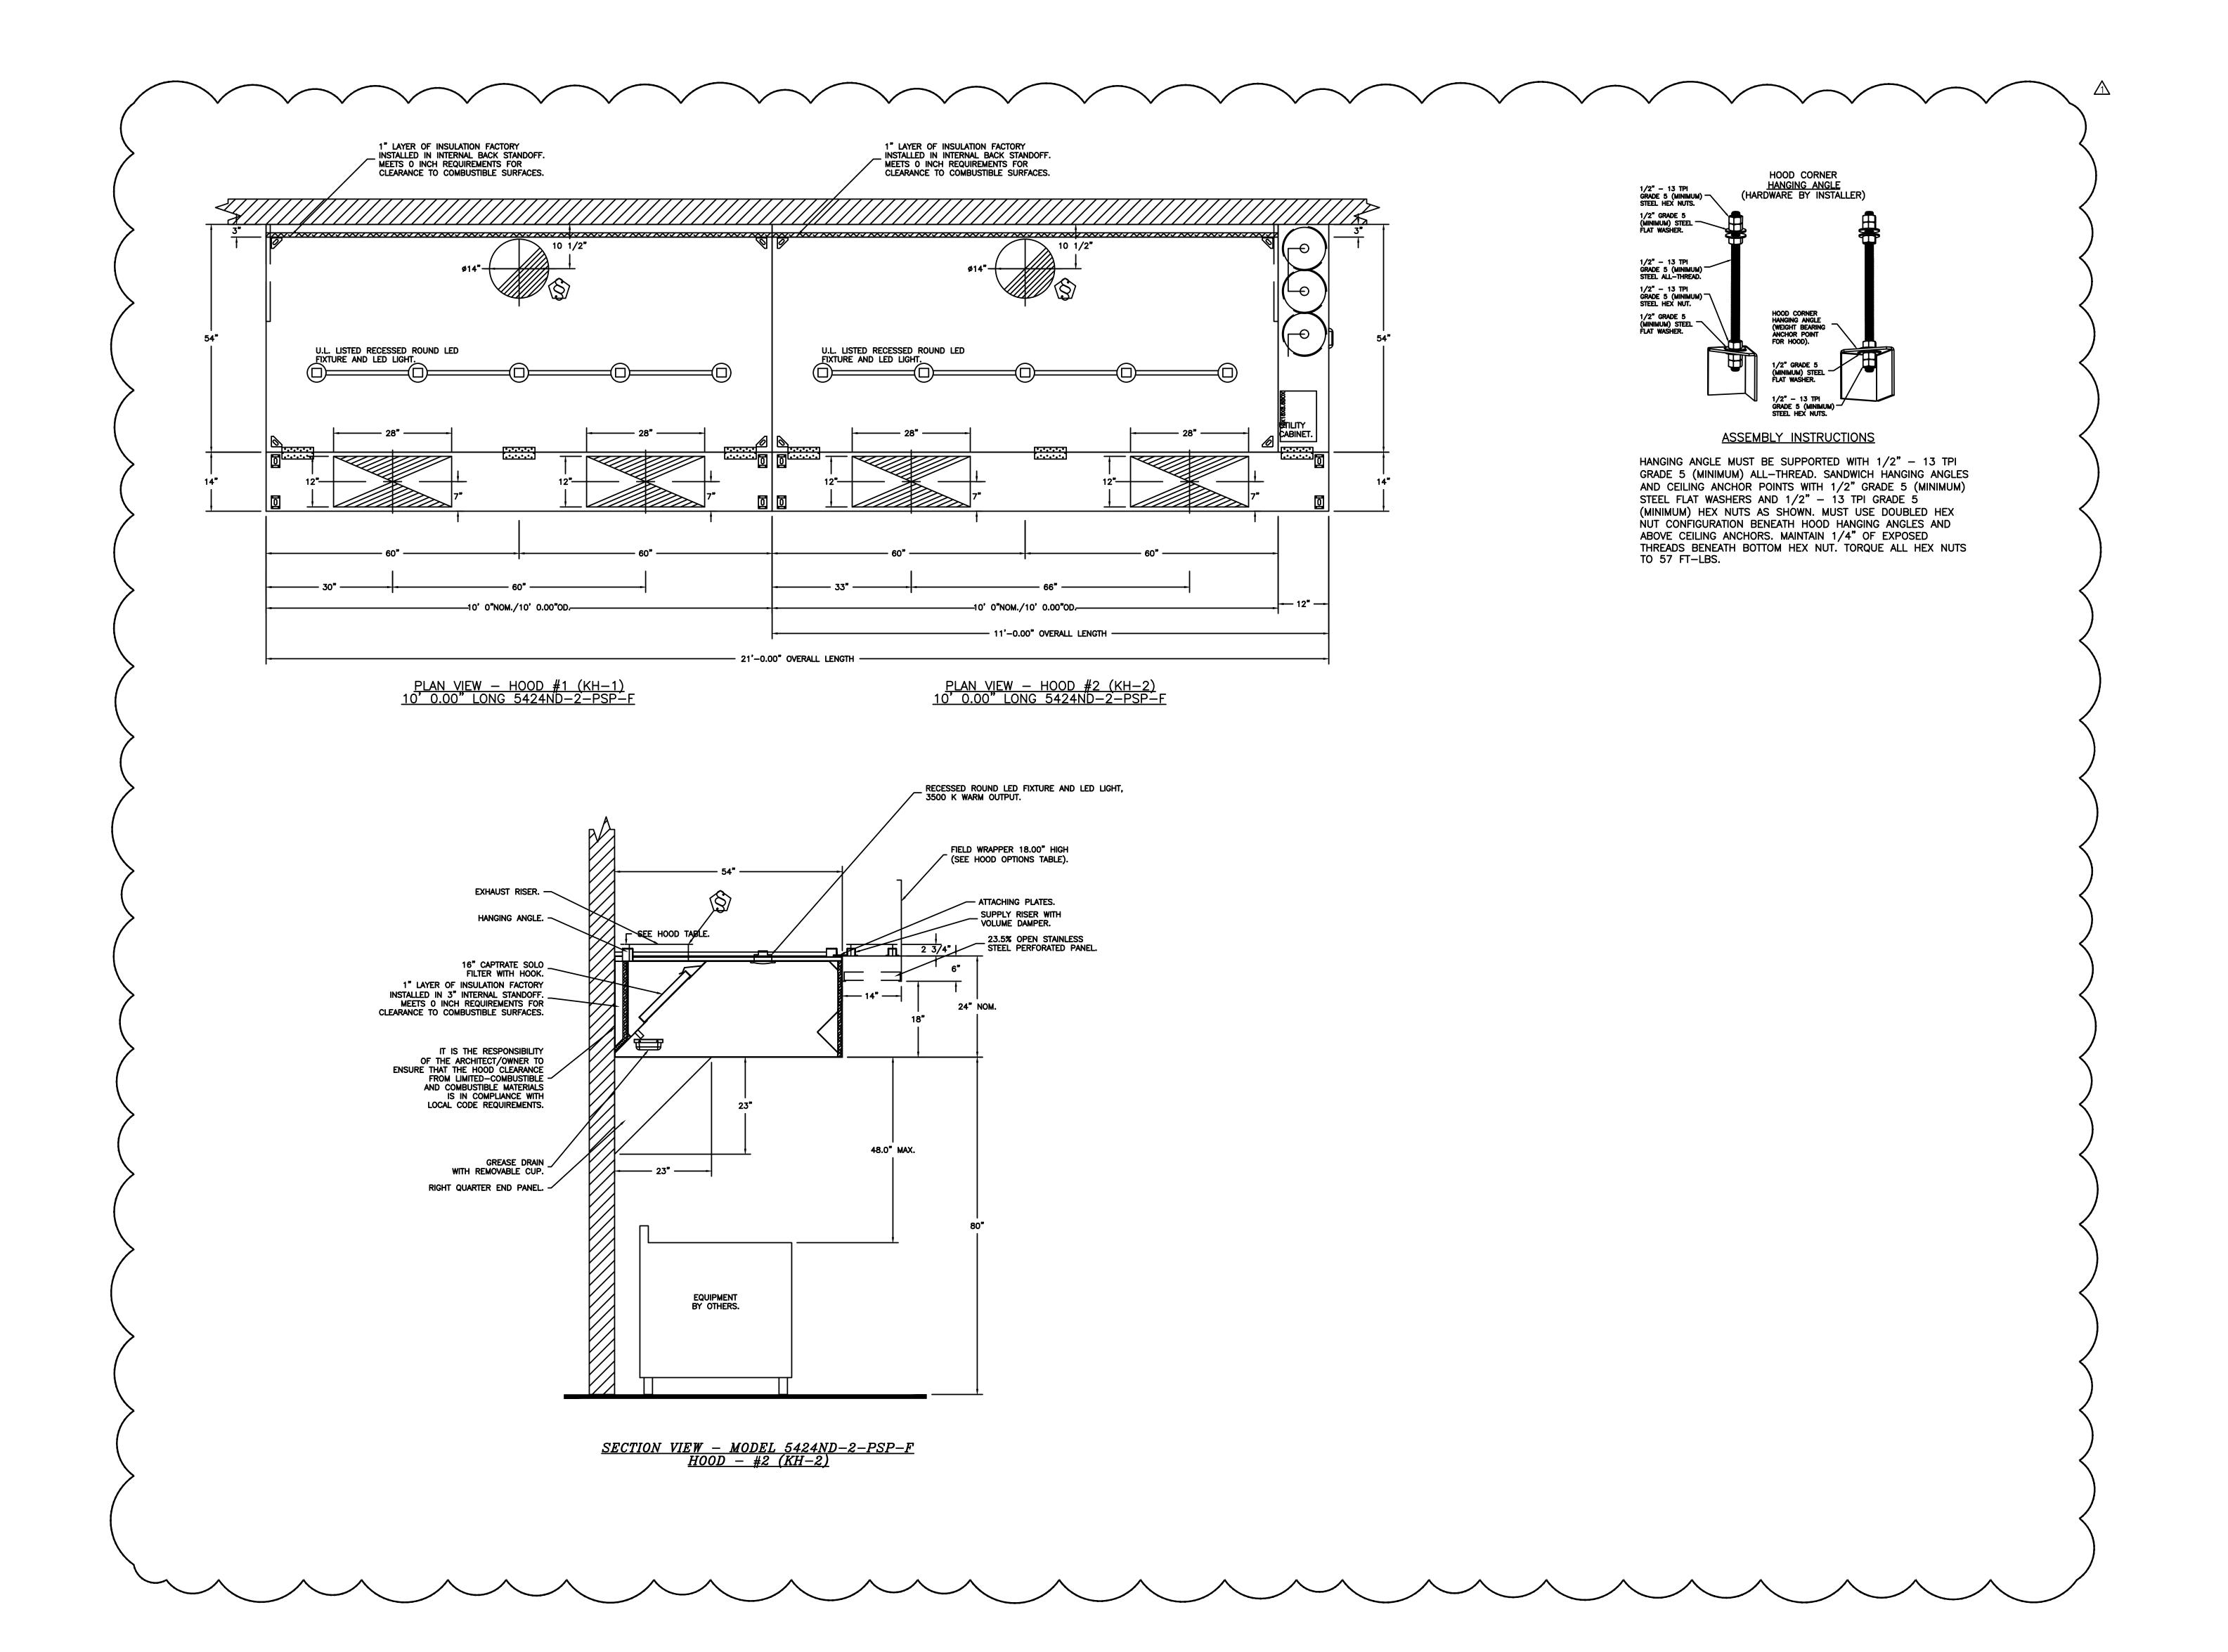Carteret County Schools / North Carolina

Project No.
22111


Date:
26 AUGUST, 2024

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Date:
26 AUGUST, 2024

Drawing no.


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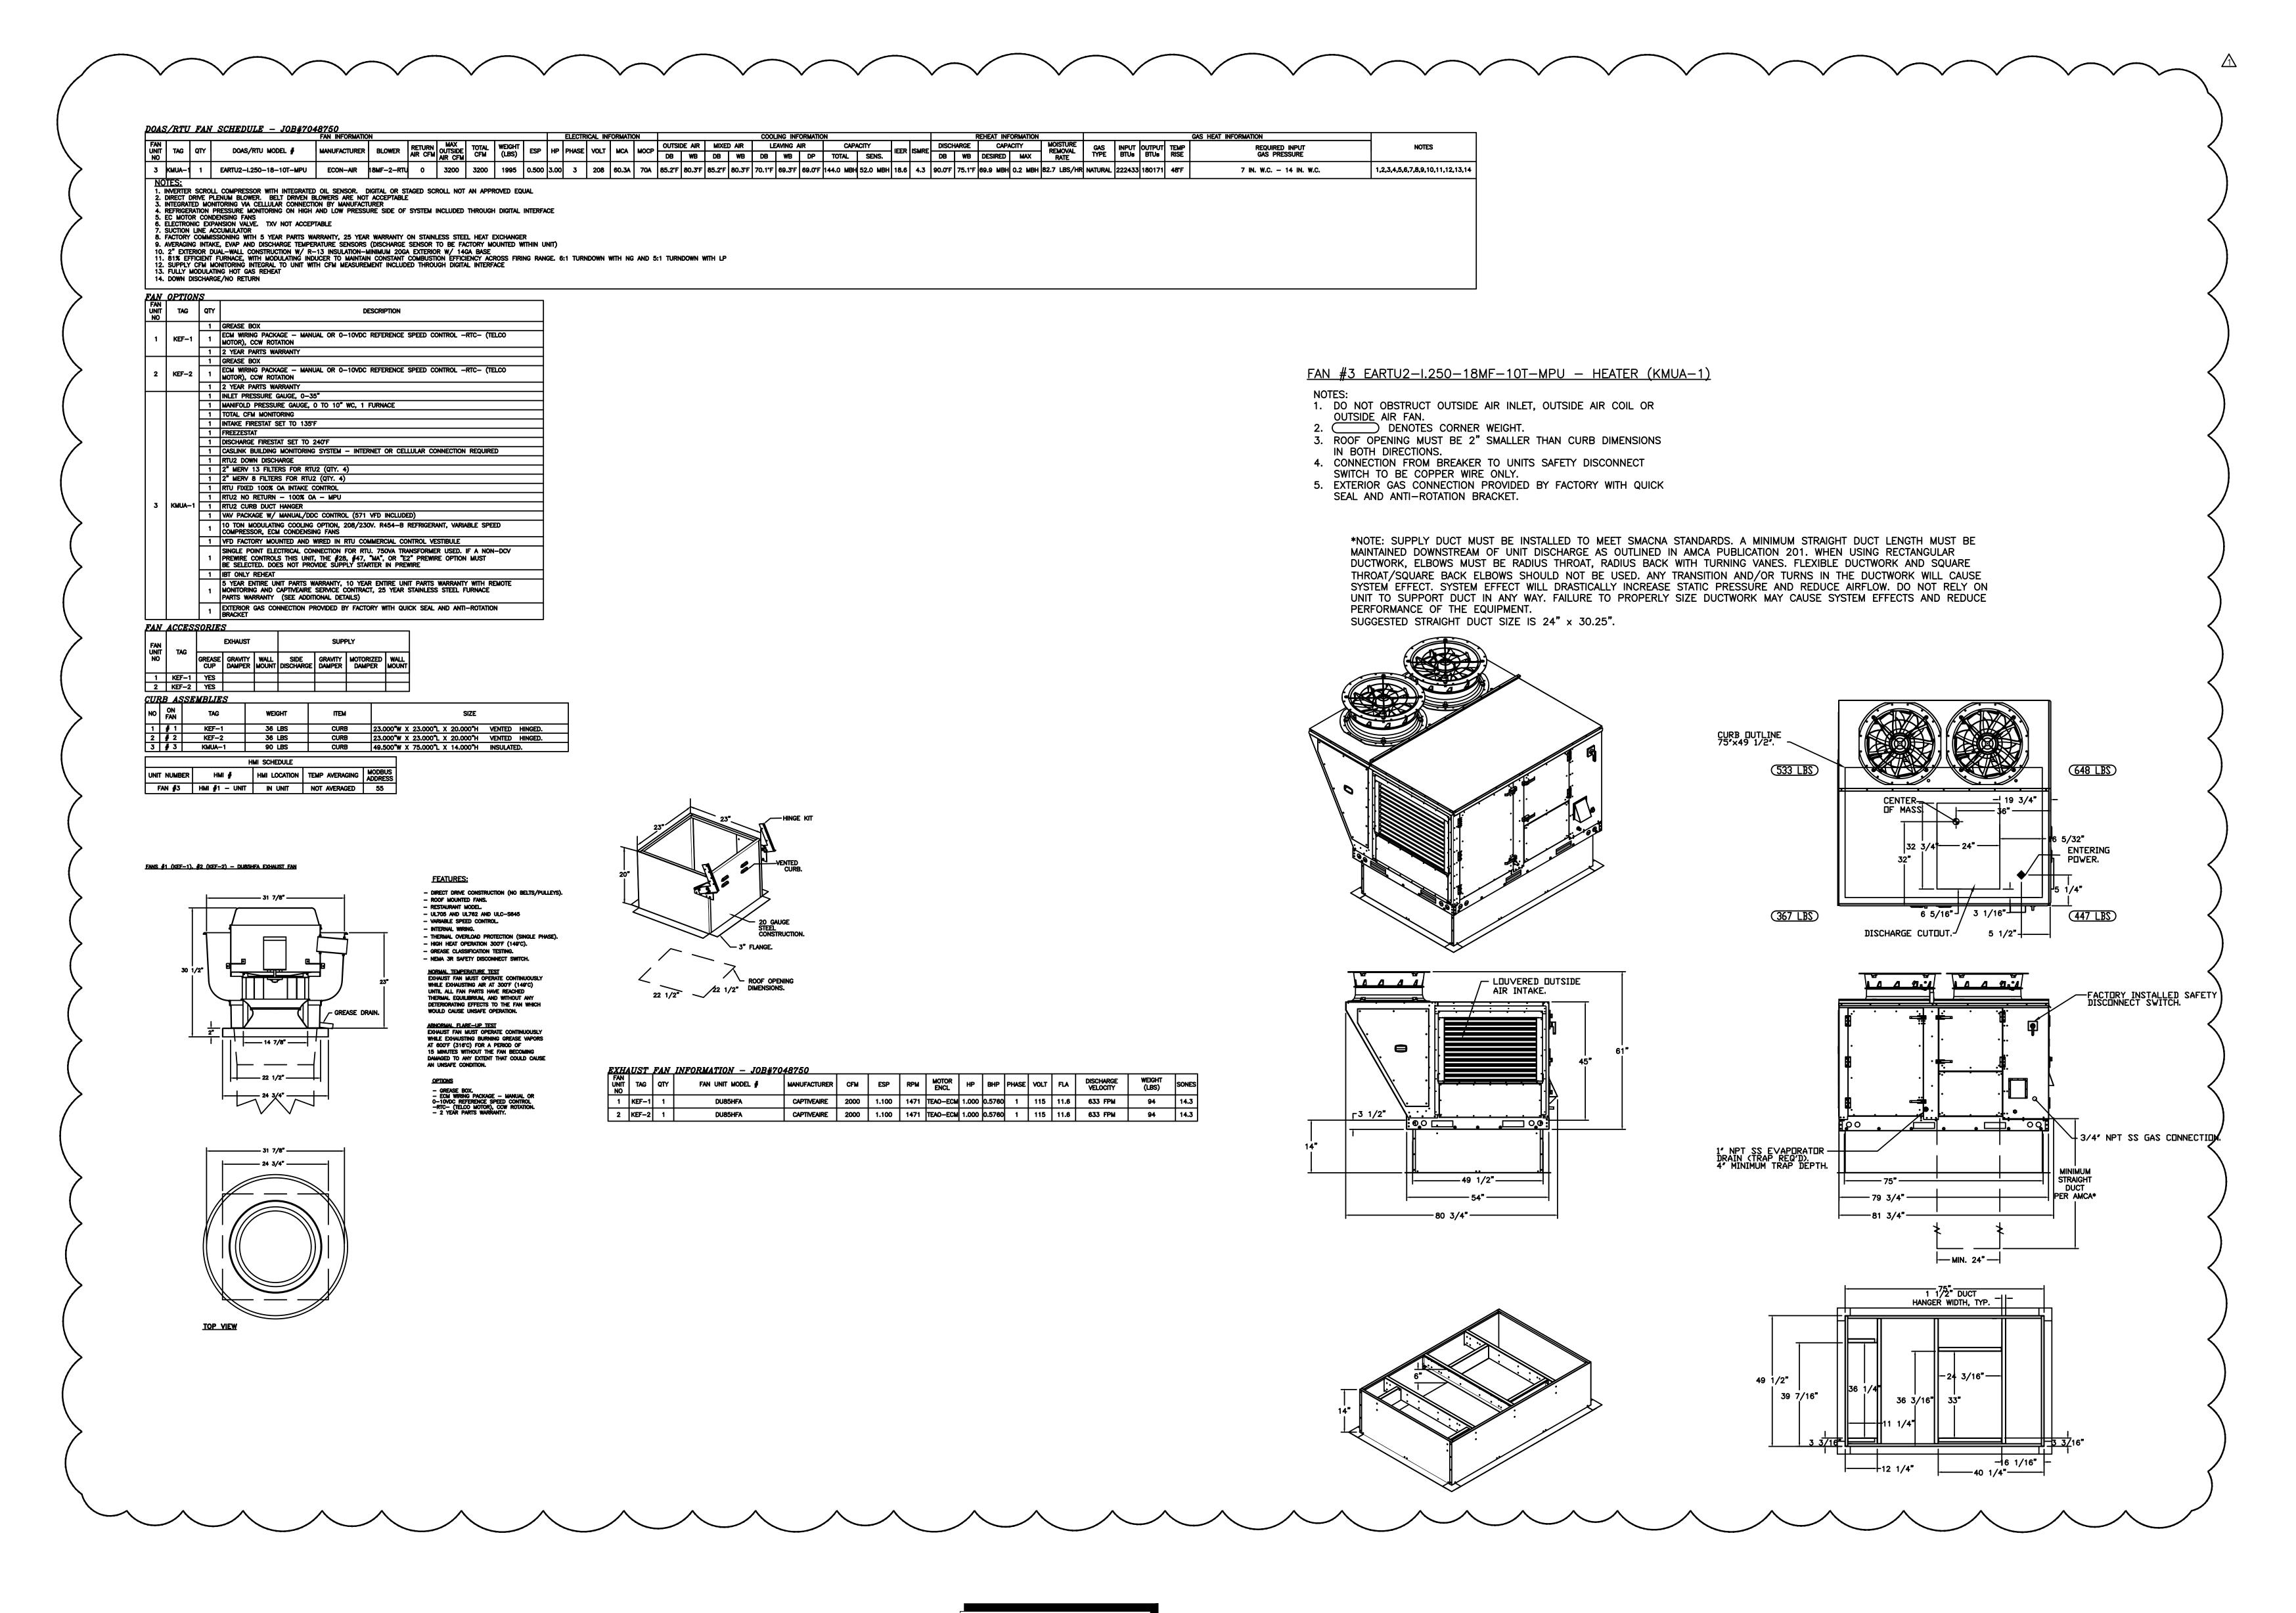
t Room Renovation

High School

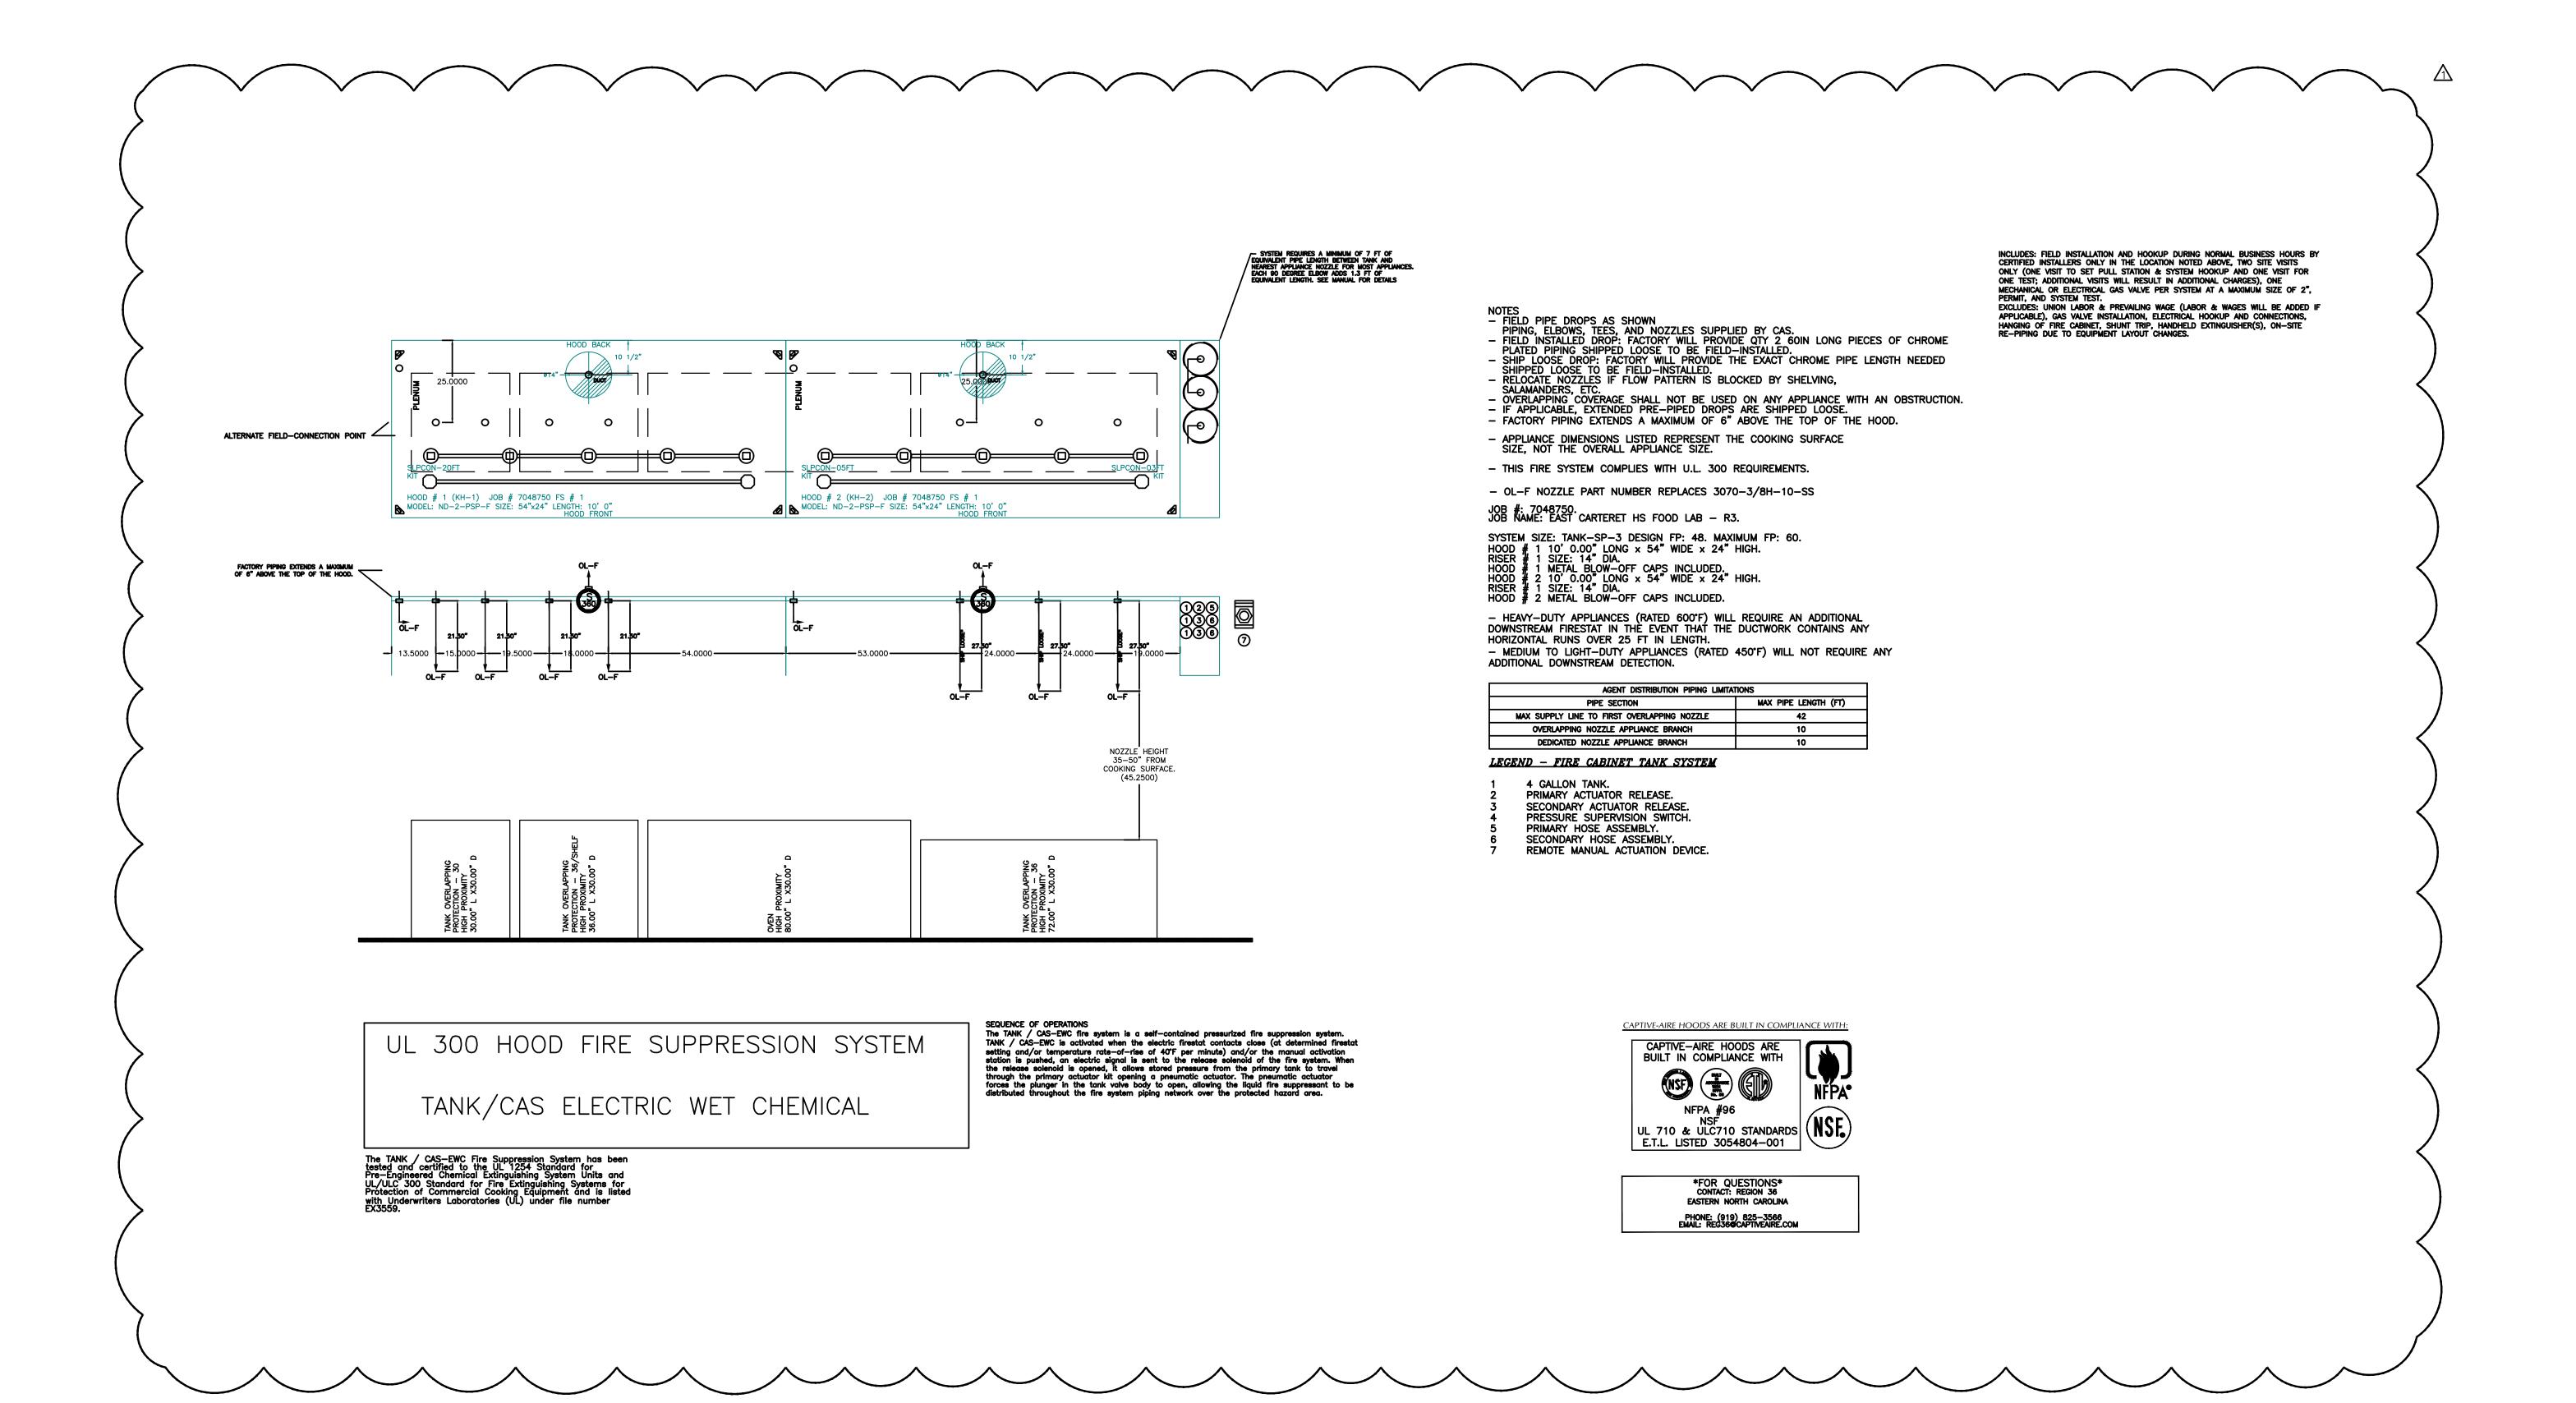
Beaufort, NC 28516

chools / North Carolina Carteret County Scho

Date: 26 AUGUST, 2024

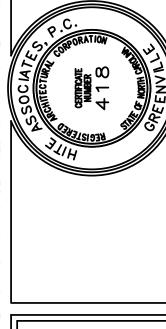

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ARCHITECTURAL DRAWINGS FOR EXACT DIMENSIONS.

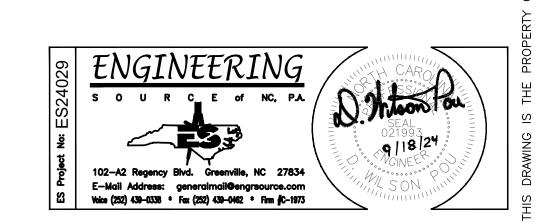1 9/18/24 ADDENDUM #1 - REMOVE ART ROOM

A TELL MORTH CONTROL NUMBER A 1 8 MONTH CONTROL OF FRANCE OF FRANC

Carteret High School


Project No. 22111

Date: 26 AUGUST, 20


22111

Date: 26 AUGUST, 2024

Drawing no.

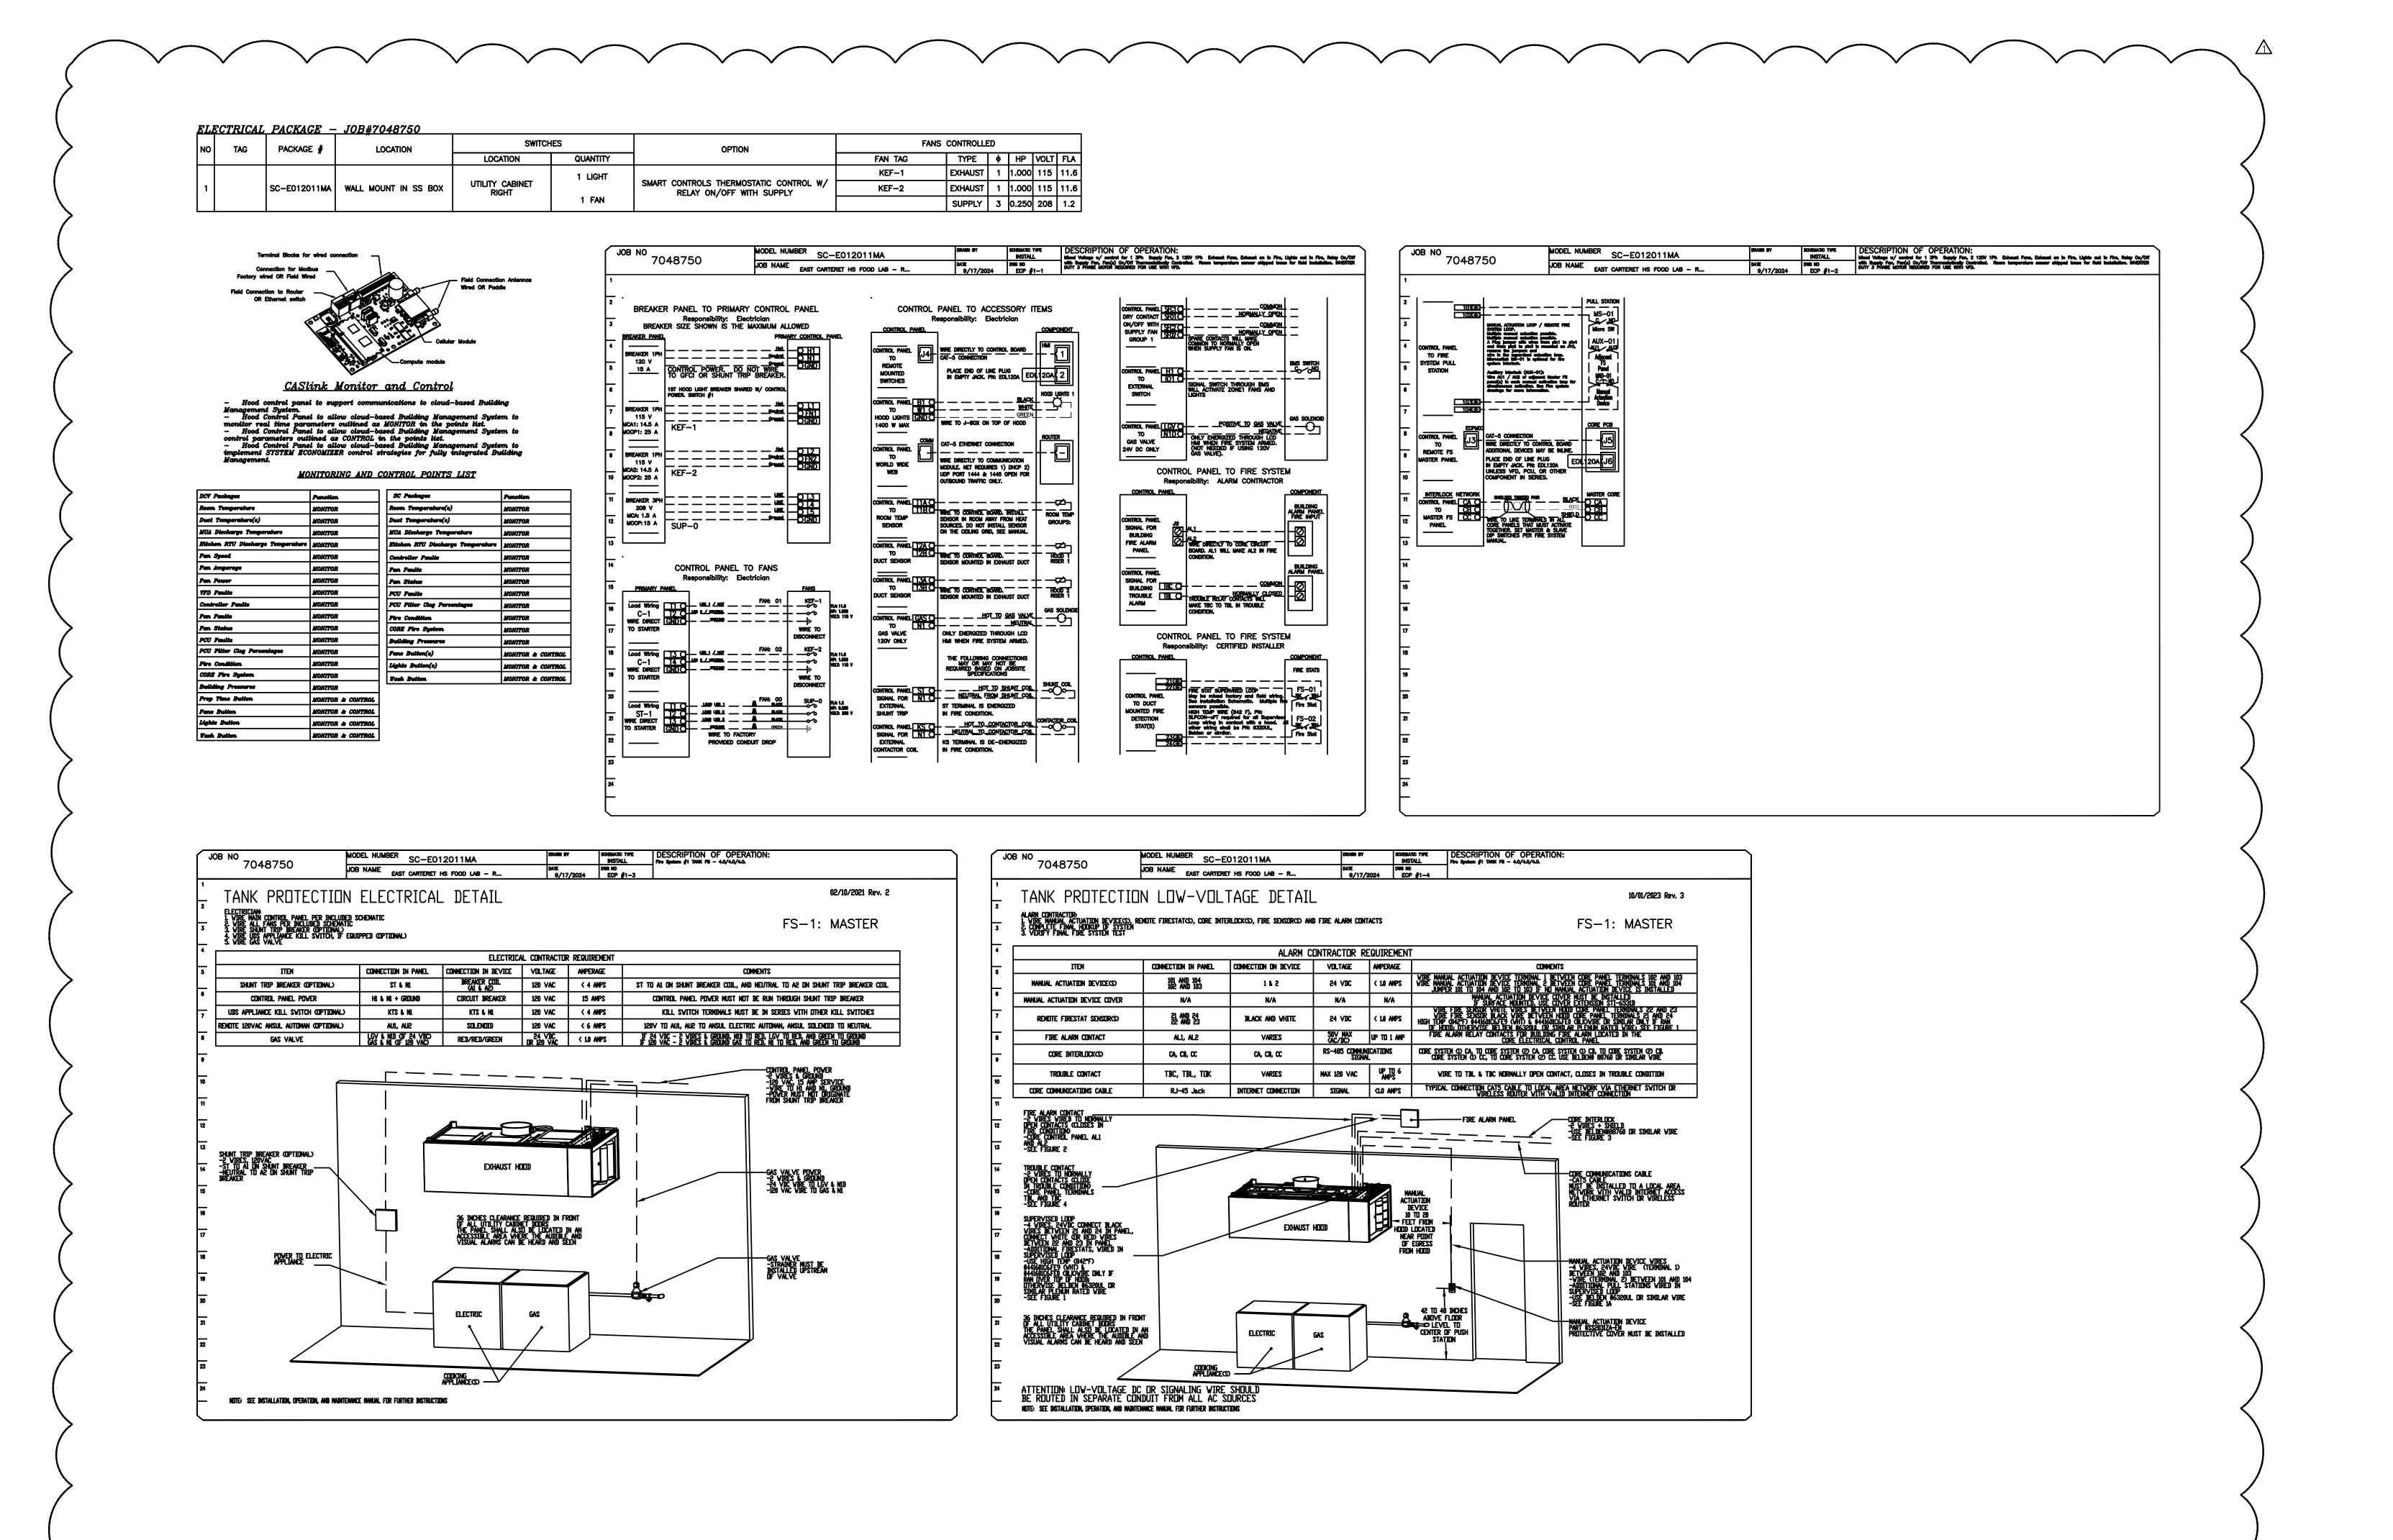

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Date:
26 AUGUST, 2024

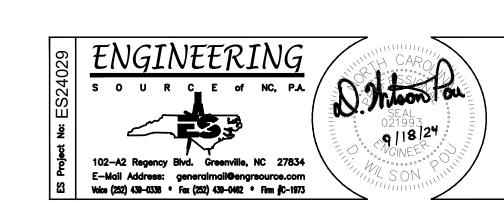Drawing no.

Food Lab And Art Room Renovation


East Cartert High Schools

Saba Hwy. 70, Beaufort, NC 28516

Carteret County Schools / North Carolina

45 #

HITE PARCHITECTU

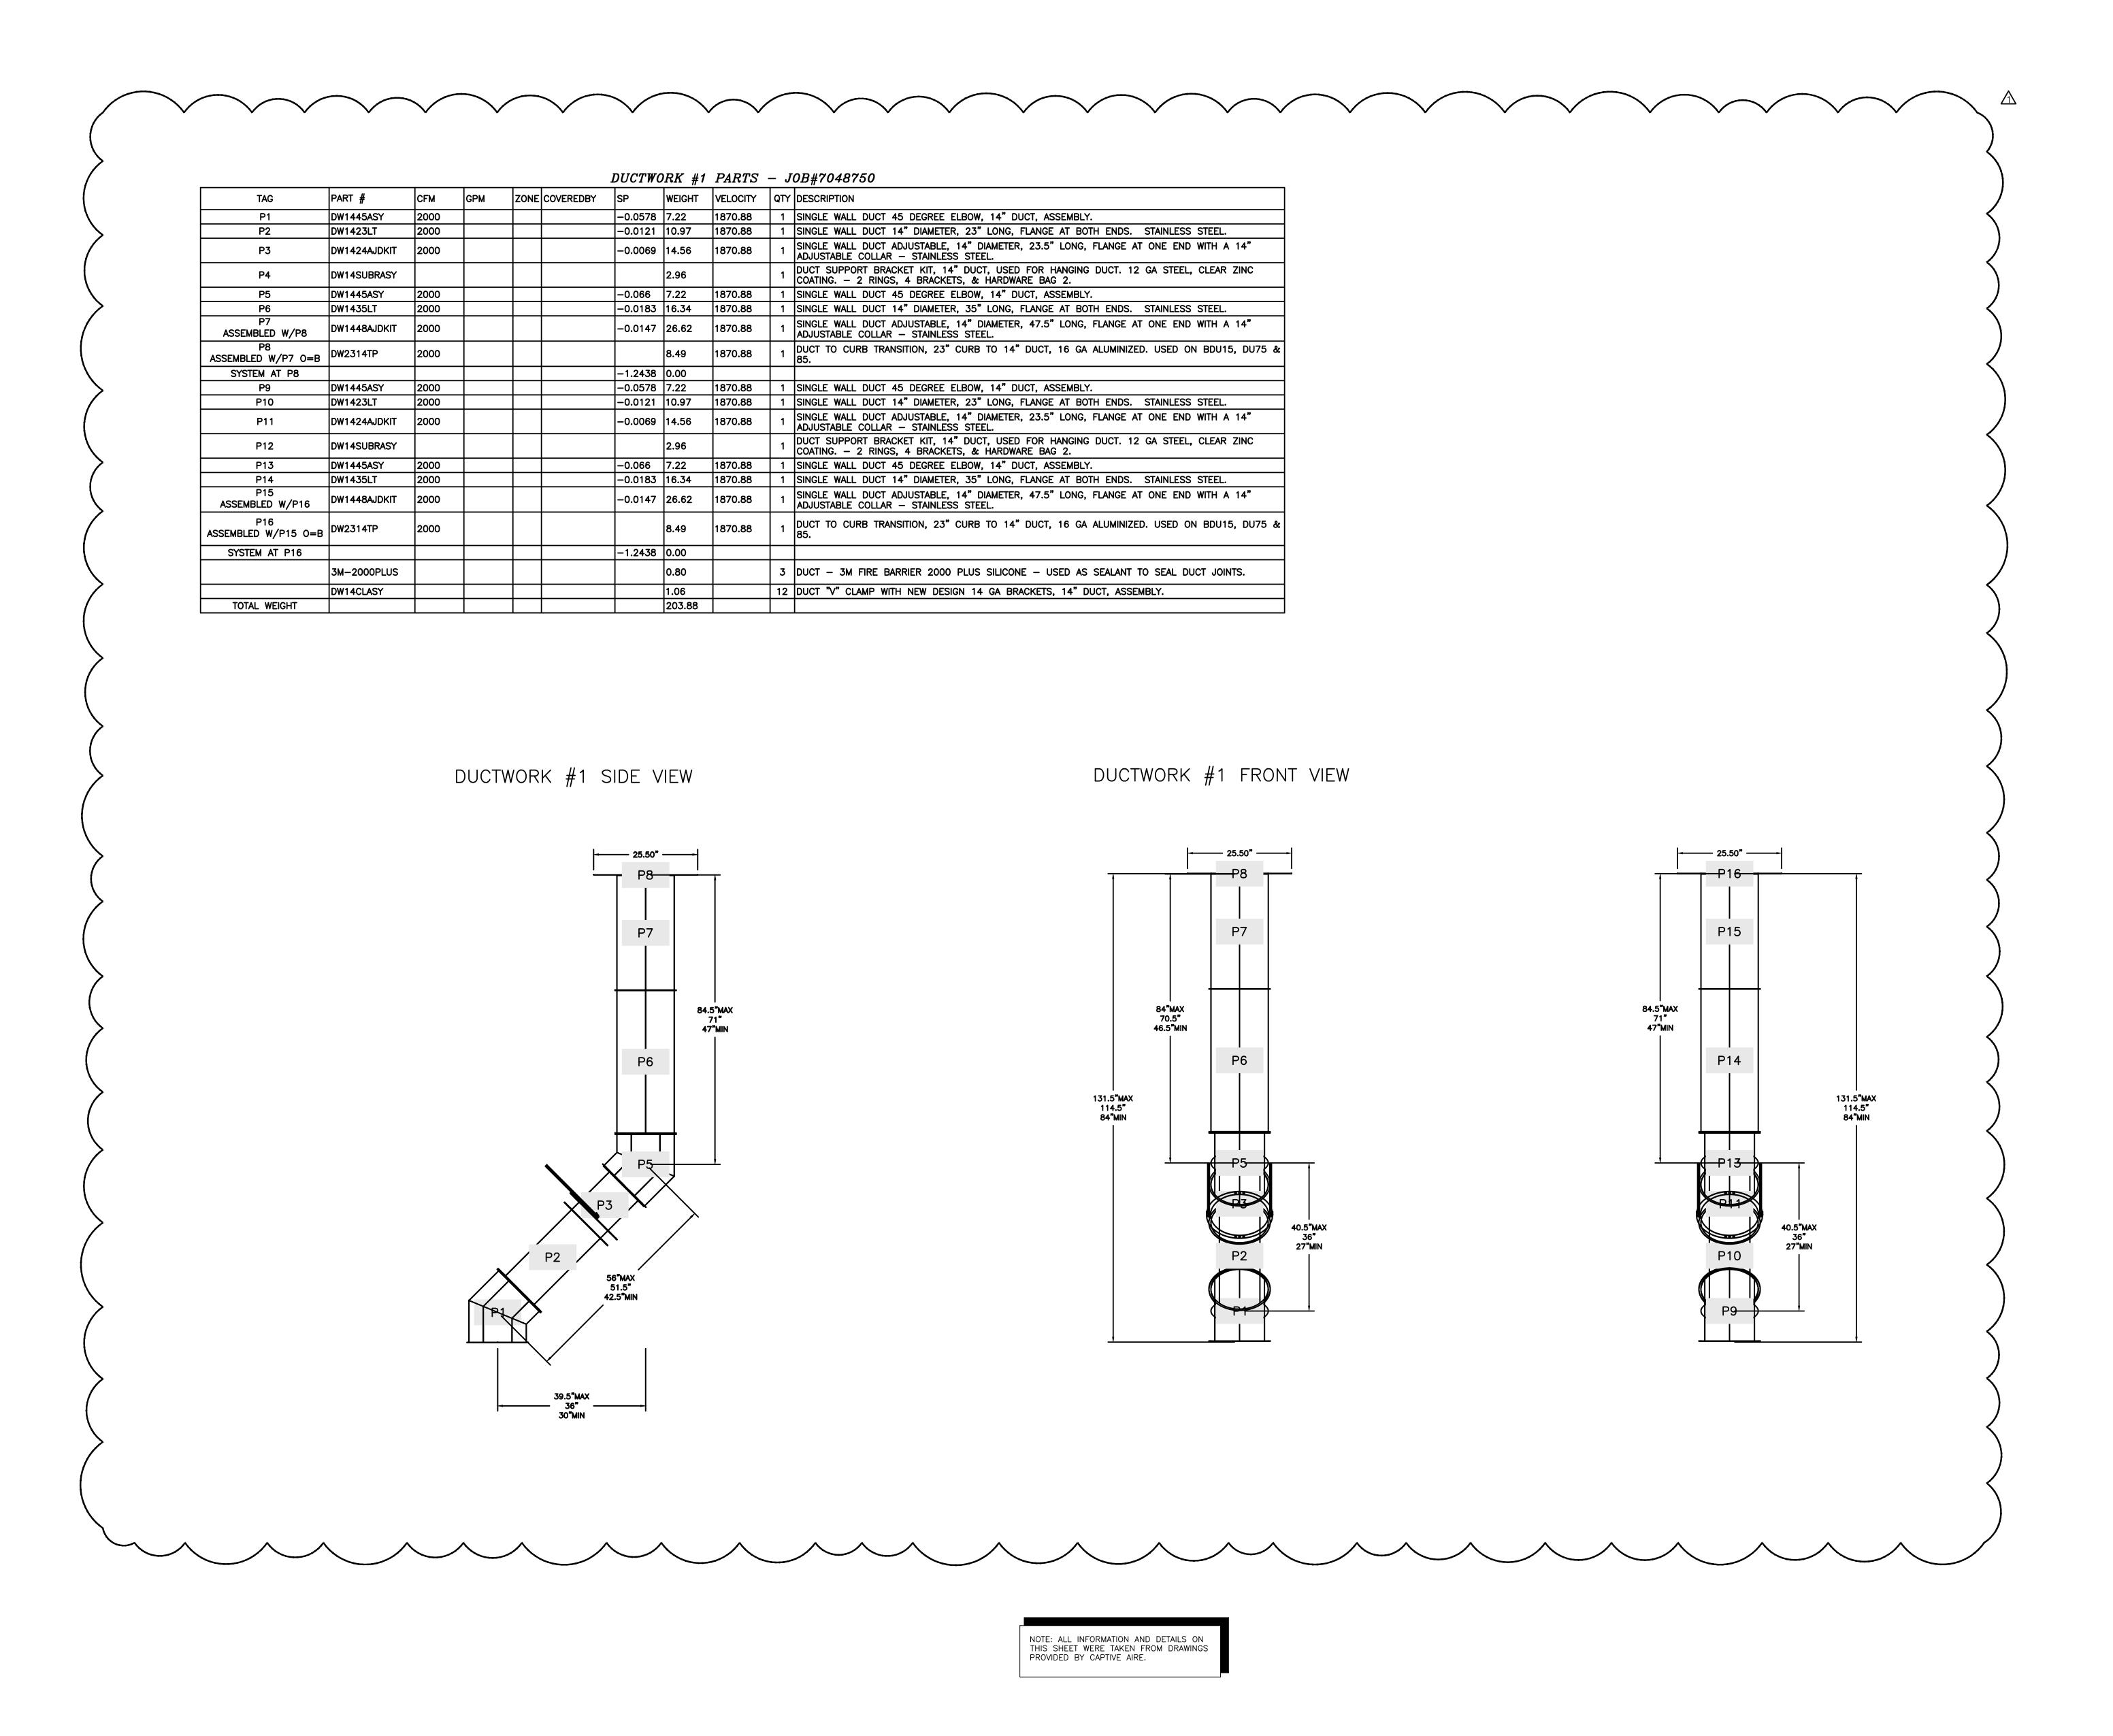

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SEAL

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Food Lab And Art Room Renov

Food Lab And Art Room Renov

Bast Carteret County Schools / North Carolii

Carteret County Schools / North Carolii

Project No. 22111

Date: 26 AUGUST, 2024

Drawing no. 718