

Security Improvements for

Warren Williams Elementary School

Lee County Schools
NCDSP Unit 530

901 Lawrence Street, Sanford, NC 27330

DRAWING INDEX

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Hite associates
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DRAWING SYMBOLS/ ABBREVIATIONS

DRAWING IDENTIFICATION MARKERS

101.1
DRAWING NUMBER
SHEET NUMBER

101.2
SECTION MARKER

101.2
ELEVATION MARKER


A-102

DOOR SCHEDULE

MARK	SIZE (INCHES) THICKNESS	LOCATION	TYPE	DESCRIPTION	FRAME MATL.	FRAME WIDTH	FIRE RATING	1	2	3	4	5	6	7	8	9	10	11	12	13	14	15	16	17	18	19	20	21	22	23	24	25	26	27	28	29	30	COMMENTS		
1	1.75 42 82	EXT TO VESTIBULE	AL-1	ALUMINUM / GLASS	ALUMINUM	4-1/2" ALUM. FRAME		1	1	1	1	1	1	1	1	1	1	1	1	1	1	1	1	1	1	1	1	1	1	1	1	1	1	1	1	1				
2	1.75 42 82	VESTIBULE TO CORRIDOR	AL-2	ALUMINUM / GLASS	ALUMINUM	4-1/2" ALUM. FRAME		1	1	1	1	1	1	1	1	1	1	1	1	1	1	1	1	1	1	1	1	1	1	1	1	1	1	1	1	1	1	PROVIDE STEEL FRAME TO 96" WITH FIXED WOOD TRANSOM		
3	1.75 36 82	OFFICE TO CORRIDOR	WD-2	FLUSH WOOD / VIEW GLASS	STEEL	7.75" STEEL	20 MN																														1	PROVIDE STEEL FRAME TO 96" WITH FIXED WOOD TRANSOM		
4	1.75 36 82	OFFICE TO OFFICE	WD-2	FLUSH WOOD / VIEW GLASS	STEEL	7.75" STEEL	20 MN																														1	PROVIDE STEEL FRAME TO 96" WITH FIXED WOOD TRANSOM		
5	1.75 36 82	OFFICE TO CORRIDOR	WD-2	FLUSH WOOD / VIEW GLASS	STEEL	7.75" STEEL	20 MN																														1	PROVIDE STEEL FRAME TO 96" WITH FIXED WOOD TRANSOM		
6	1.75 36 82	OFFICE TO CORRIDOR	WD-2	FLUSH WOOD / VIEW GLASS	STEEL	7.75" STEEL	20 MN																														1	PROVIDE STEEL FRAME TO 96" WITH FIXED WOOD TRANSOM		
7	1.75 30 82	STAFF TOILET TO CORRIDOR	WD-1	FLUSH WOOD	STEEL	7.75" STEEL	20 MN																														1	PROVIDE STEEL FRAME TO 96" WITH FIXED WOOD TRANSOM		
8	1.75 30 82	STUDENT TOILET TO CORRIDOR	WD-1	FLUSH WOOD	STEEL	7.75" STEEL	20 MN																														1	PROVIDE STEEL FRAME TO 96" WITH FIXED WOOD TRANSOM		
9	1.75 36 82	CUSTODIAN TO CORRIDOR	WD-1	FLUSH WOOD	STEEL	7.75" STEEL	20 MN																														1	PROVIDE STEEL FRAME TO 96" WITH FIXED WOOD TRANSOM		
10	1.75 30 82	STUDENT TOILET TO CORRIDOR	WD-1	FLUSH WOOD	STEEL	7.75" STEEL	20 MN																														1	PROVIDE STEEL FRAME TO 96" WITH FIXED WOOD TRANSOM		
11	1.75 36 82	CLASSROOM TO CORRIDOR	WD-2	FLUSH WOOD / VIEW GLASS	STEEL	7.75" STEEL	20 MN																														1	PROVIDE STEEL FRAME TO 96" WITH FIXED WOOD TRANSOM		
12	1.75 36 82	CLASSROOM TO CORRIDOR	WD-2	FLUSH WOOD / VIEW GLASS	STEEL	7.75" STEEL	20 MN																														1	PROVIDE STEEL FRAME TO 96" WITH FIXED WOOD TRANSOM		
13	1.75 36 82	CLASSROOM TO CORRIDOR	WD-2	FLUSH WOOD / VIEW GLASS	STEEL	7.75" STEEL	20 MN																														1	PROVIDE STEEL FRAME TO 96" WITH FIXED WOOD TRANSOM		
14	1.75 36 82	CLASSROOM TO CORRIDOR	WD-2	FLUSH WOOD / VIEW GLASS	STEEL	7.75" STEEL	20 MN																														1	PROVIDE STEEL FRAME TO 96" WITH FIXED WOOD TRANSOM		
15	1.75 36 82	CLASSROOM TO CORRIDOR	WD-2	FLUSH WOOD / VIEW GLASS	STEEL	7.75" STEEL	20 MN																														1	PROVIDE STEEL FRAME TO 96" WITH FIXED WOOD TRANSOM		
16	1.75 36 82	CLASSROOM TO CORRIDOR	WD-2	FLUSH WOOD / VIEW GLASS	STEEL	7.75" STEEL	20 MN																														1	PROVIDE STEEL FRAME TO 96" WITH FIXED WOOD TRANSOM		
17	1.75 36 82	CLASSROOM TO CORRIDOR	WD-2	FLUSH WOOD / VIEW GLASS	STEEL	7.75" STEEL	20 MN																														1	PROVIDE STEEL FRAME TO 96" WITH FIXED WOOD TRANSOM		
18	1.75 36 82	CLASSROOM TO CORRIDOR	WD-2	FLUSH WOOD / VIEW GLASS	STEEL	7.75" STEEL	20 MN																														1	PROVIDE STEEL FRAME TO 96" WITH FIXED WOOD TRANSOM		
19	1.75 36 82	EXT TO COMMONS	AL-1	ALUMINUM / GLASS	ALUMINUM	4.5" ALUM																															1	PROVIDE STEEL FRAME TO 96" WITH FIXED WOOD TRANSOM		
20	1.75 36 82	EXT TO COMMONS	AL-1	ALUMINUM / GLASS	ALUMINUM	4.5" ALUM																																1	PROVIDE STEEL FRAME TO 96" WITH FIXED WOOD TRANSOM	
21	1.75 36 82	CLASSROOM TO CORRIDOR	WD-2	FLUSH WOOD / VIEW GLASS	STEEL	7.75" STEEL	20 MN																															1	PROVIDE STEEL FRAME TO 96" WITH FIXED WOOD TRANSOM	
22	1.75 36 82	CLASSROOM TO CORRIDOR	WD-2	FLUSH WOOD / VIEW GLASS	STEEL	7.75" STEEL	20 MN																															1	PROVIDE STEEL FRAME TO 96" WITH FIXED WOOD TRANSOM	
23	1.75 36 82	CLASSROOM TO CORRIDOR	WD-2	FLUSH WOOD / VIEW GLASS	STEEL	7.75" STEEL	20 MN																															1	PROVIDE STEEL FRAME TO 96" WITH FIXED WOOD TRANSOM	
24	1.75 36 82	CLASSROOM TO CORRIDOR	WD-2	FLUSH WOOD / VIEW GLASS	STEEL	7.75" STEEL	20 MN																															1	PROVIDE STEEL FRAME TO 96" WITH FIXED WOOD TRANSOM	
25	1.75 36 82	CLASSROOM TO CORRIDOR	WD-2	FLUSH WOOD / VIEW GLASS	STEEL	7.75" STEEL	20 MN																															1	PROVIDE STEEL FRAME TO 96" WITH FIXED WOOD TRANSOM	
26	1.75 36 82	OFFICE TO CORRIDOR	WD-2	FLUSH WOOD / VIEW GLASS	STEEL	7.75" STEEL	20 MN																															1	PROVIDE STEEL FRAME TO 96" WITH FIXED WOOD TRANSOM	
27	1.75 36 82	OFFICE TO CORRIDOR	WD-2	FLUSH WOOD / VIEW GLASS	STEEL	7.75" STEEL	20 MN																															1	PROVIDE STEEL FRAME TO 96" WITH FIXED WOOD TRANSOM	
28	1.75 36 86	EXT TO EXT	FB-1	FIBERGLASS / VIEW GLASS	ALUMINUM	6" ALUM		1	1	1	1	1	1	1	1	1	1	1	1	1	1	1	1	1	1	1	1	1	1	1	1	1	1	1	1	1	1	1	PROVIDE STEEL FRAME TO 96" WITH FIXED WOOD TRANSOM	
29	1.75 36 86	EXT TO EXT	FB-1	FIBERGLASS / VIEW GLASS	ALUMINUM	6" ALUM		1	1	1	1	1	1	1	1	1	1	1	1	1	1	1	1	1	1	1	1	1	1	1	1	1	1	1	1	1	1	1	1	PROVIDE STEEL FRAME TO 96" WITH FIXED WOOD TRANSOM
30		EXT BUS PARKING TO COMMONS	FB-1	EXISTING TO REMAIN	ALUMINUM	6" ALUM		1	1	1	1	1	1	1	1	1	1	1	1	1	1	1	1	1	1	1	1	1	1	1	1	1	1	1	1	1	1	1	PROVIDE STEEL FRAME TO 96" WITH FIXED WOOD TRANSOM	

- NOTES AND GENERAL AND SPECIAL HARDWARE REQUIRED**
- ALL DOORS TO RECEIVE HINGES AS SPECIFIED
 - ALL DOORS TO RECEIVE WALL OR OVERHEAD STOPS TO SUIT CONDITION OF USE. DOORS WITH MAGNETIC HOLD OPENS TO RECEIVE FLOOR STOPS.
 - PROVIDE CLOSERS WITH BACKSTOPS EXTERIOR DOORS AND TO SUIT CONDITION OF USE. ALL CLOSERS TO BE THROUGH-BOLTED
 - ALL STEEL FRAMES TO BE PROVIDED WITH SILENCERS
 - EXTERIOR AND IDF ROOM DOORS TO BE PROVIDED WITH WEATHERSTRIPPING AND THRESHOLDS
 - EXIT DEVICES TO BE PROVIDED WITH CYLINDERS, LOCKS, AND CD CYLINDER DOGGING
 - AT PAIRS OF DOORS, PULL SIDE. PROVIDE PULL OR LEVER BOTH SIDES ONLY UNLESS OTHERWISE NOTED
 - ALUMINUM DOORS - SEE SPECIFICATIONS FOR HARDWARE NOT INDICATED ABOVE
 - PROVIDE CYLINDERS FOR KEYS MILLIONS SUPPLIED BY ALUMINUM DOOR SUPPLIER
 - PROVIDE SOLID WOOD BLOCKING FOR DOOR STOPS AND HOLD OPEN DEVICES
 - EXIT DEVICES AT EXTERIOR DOORS TO BE NL WITH PULL, UNLESS OTHERWISE INDICATED
 - EXIT DEVICES AT INTERIOR DOORS TO BE CLASSROOM FUNCTION WITH LEVER
 - PROVIDE 4" WIDE STEEL JAMBS FOR DOORS ABUTTING STEEL COLUMNS AND SPECIAL CONDITIONS AS NOTED

REMOVE EXISTING WOOD DOORS, WOOD FRAMES COMPLETE AND PREPARE FOR NEW STEEL FRAMES, WOOD DOORS AND HARDWARE, PAINT NEW FRAMES AS SPECIFIED - TYPICAL

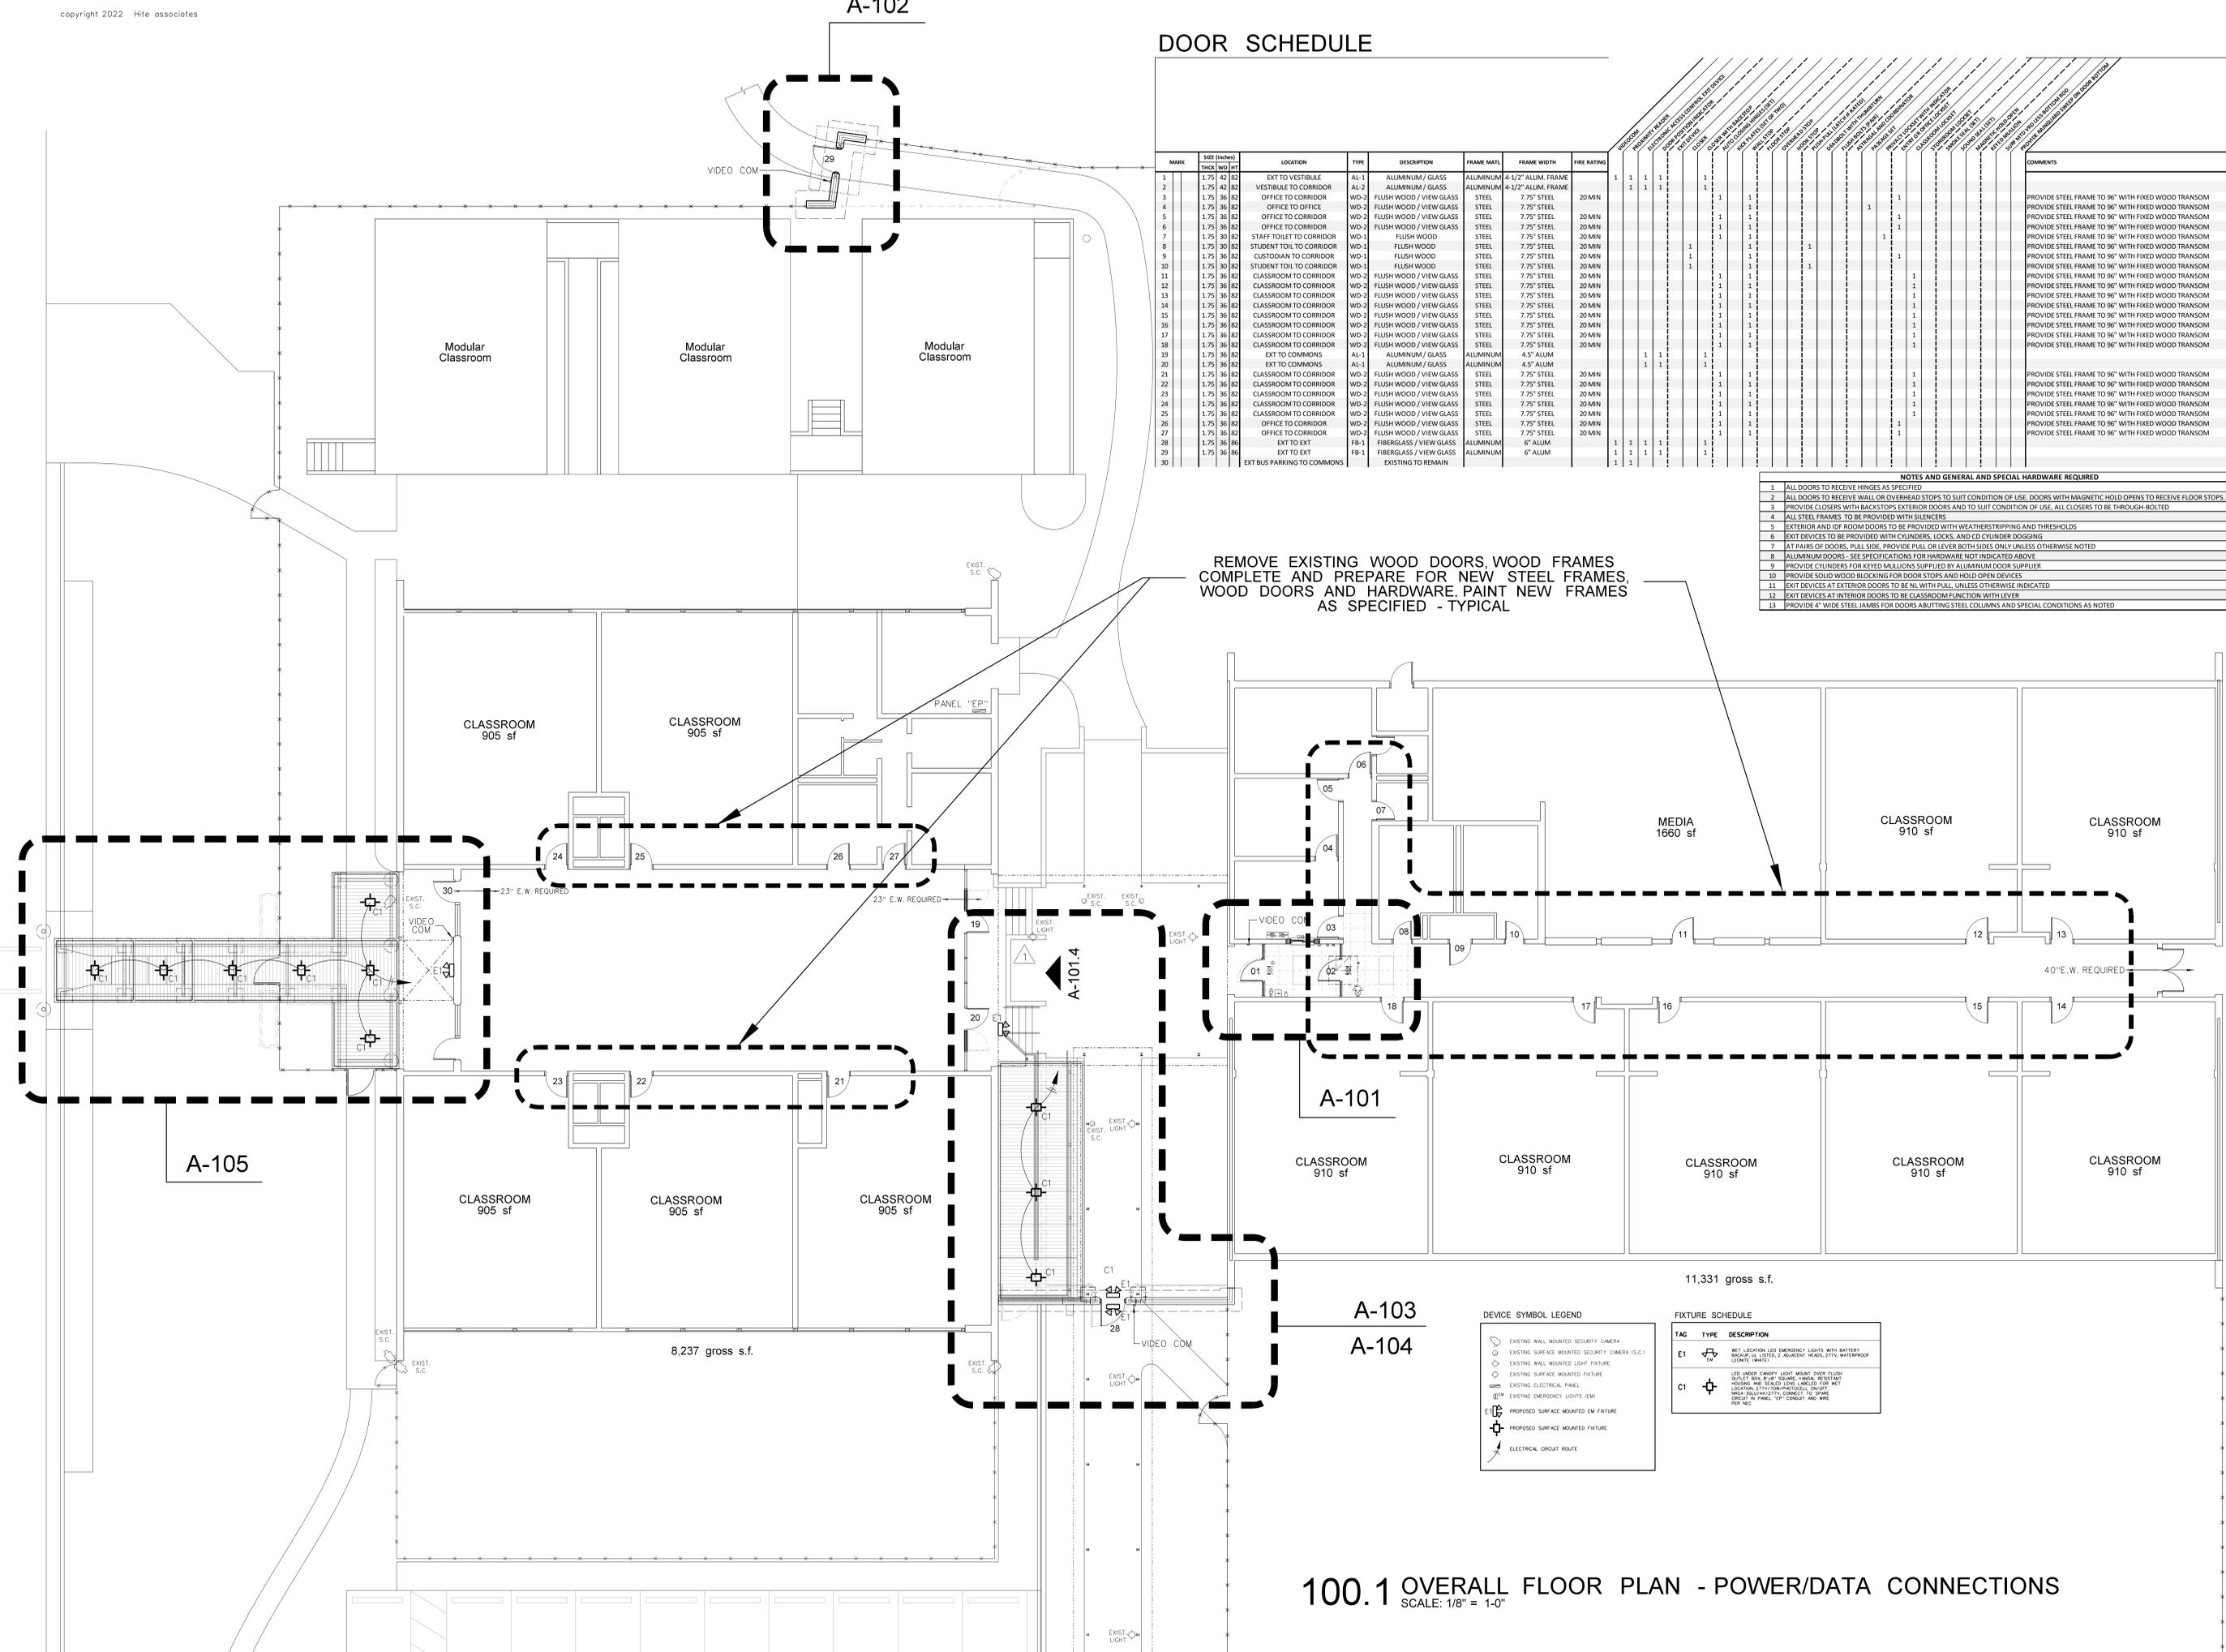

100.1 OVERALL FLOOR PLAN - POWER/DATA CONNECTIONS
SCALE: 1/8" = 1'-0"

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Project No. 22238
Date: 13 March 2023
Drawing No. A 100


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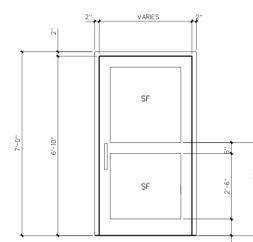
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GREENVILLE, NC


Revision
No. 1
Date:




101.4 STOREFRONT ELEVATION
SCALE: 3/8" = 1'-0"

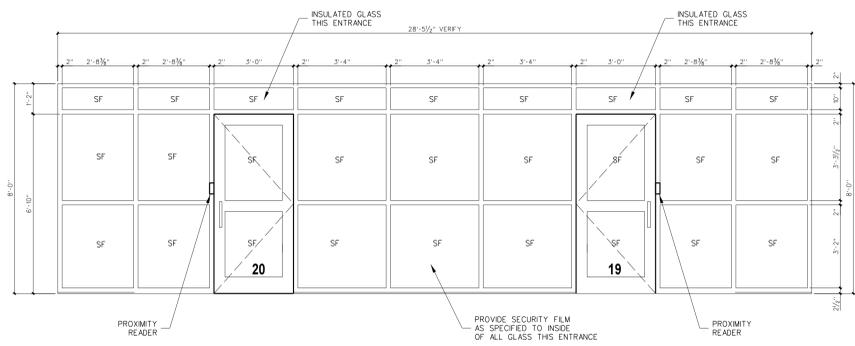


AL-1
WIDE STILE
ALUMINUM AND
5/16" SECURITY GLASS IN
ALUMINUM STOREFRONT FRAME
AS SPECIFIED

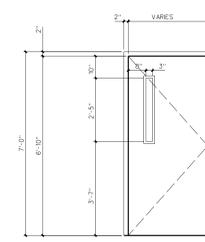

FB-1
FLUSH FRP / ALUMINUM AND
5/16" SECURITY GLASS IN
ALUMINUM FRAME
AS SPECIFIED

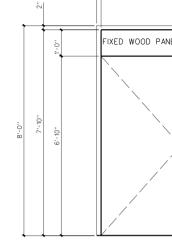


WD-1
SOLID CORE
FLUSH WOOD
IN STEEL FRAME

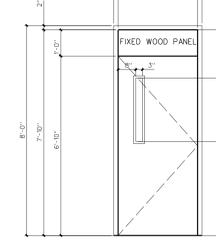


WD-2
SOLID CORE FLUSH WOOD AND
5/16" SECURITY GLASS IN
STEEL FRAME
AS SPECIFIED


101.3 DOOR ELEVATIONS
SCALE: 3/8" = 1'-0"

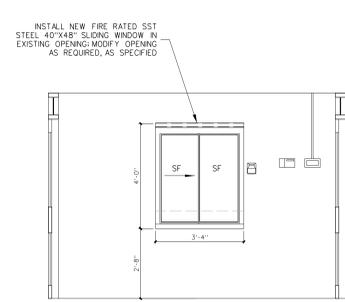

101.2-3 - Vestibule

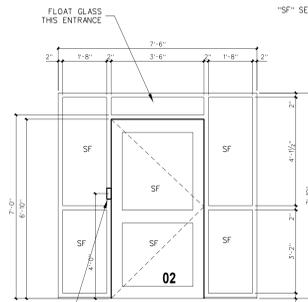


101.2-2 - Vestibule

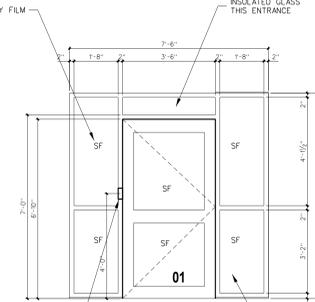

101.2-1 - Entrance

101.2 SECURITY VESTIBULE INTERIOR ELEVATIONS
SCALE: 3/8" = 1'-0"

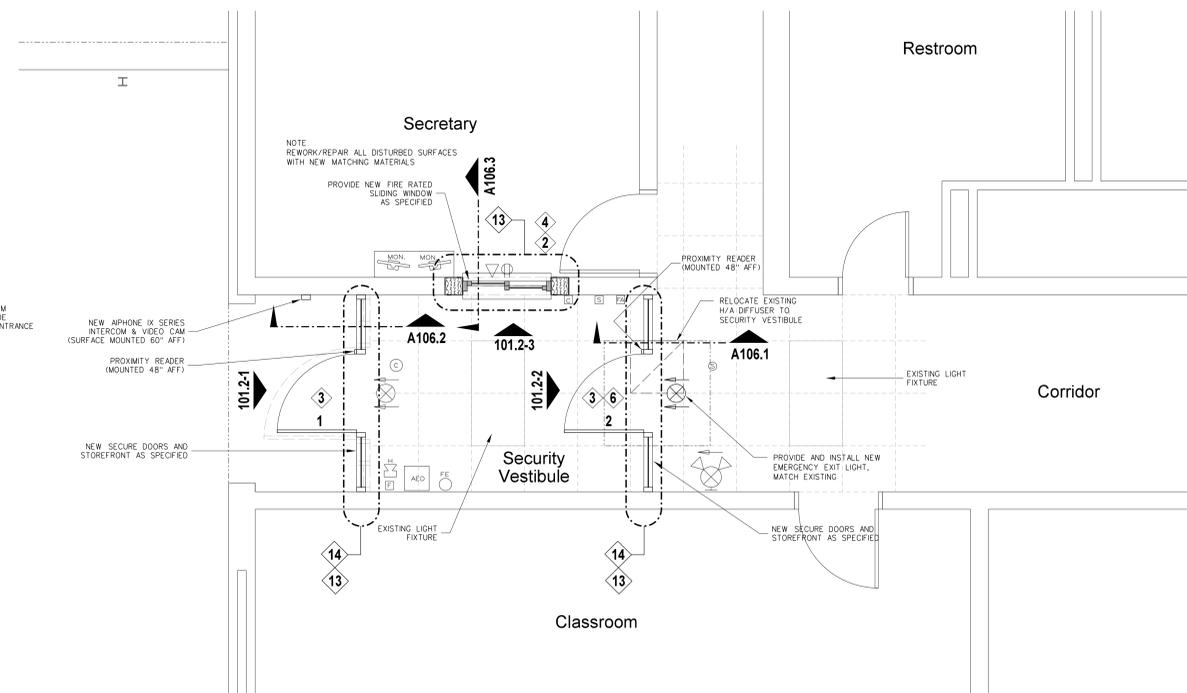


101.1 SECURITY VESTIBULE FLOOR PLAN
SCALE: 3/8" = 1'-0"

PLAN KEY NOTE / ACCESS CONTROL NOTES / GENERAL NOTES
(Apply Throughout)

- 1 GENERAL NOTE: EXISTING DOOR CALL STATION TO BE REPLACED WITH NEW IPHONE IX SERIES INTERCOM & VIDEO CAMERA.
- 2 GENERAL NOTE: EXISTING DESKTOP TWO-WAY CONTROL STATIONS TO BE REPLACED AND TIED IN TO THE NEW DOOR CALL STATIONS.
- 3 PROVIDED NEW DOORFRAME RECESSED CONTACT VON DUPRIN QEL EXIT DEVICE AND POWER SUPPLY EPT ELECTRIC POWER TRANSFER.
- 4 INSTALL COMPUTER ACCESS CONTROL BASE STATION SOFTWARE PROGRAM ON OWNER'S PC.
- 5 PROVIDE DOOR CONTACT, ELECTRIFIED MORTISE LOCKSET.
- 6 INSTALL SURFACE MOUNTED PROXIMITY CARD READER UNIT, MINI-MULLION VERSION WHERE REQUIRED.
- 7 PROVIDE EXISTING DOORFRAME CONTACT, VON DUPRIN QEL CONVERSION KIT FOR EXISTING EXIT DEVICE, POWER SUPPLY, AND ARMORED DOOR CORDS.
- 8 NOT USED.
- 9 GENERAL NOTE: PROVIDE DOOR CONTACTS ON ALL ACCESS CONTROLLED DOORS.
- 10 GENERAL NOTE: ALL ACCESS CONTROL NETWORK NODES TO BE PROVIDED IN THE SCHOOL IDF AND MDF ROOMS. FINAL LOCATIONS AS DIRECTED BY OWNER.
- 11 GENERAL NOTE: PROVIDED ALL POWER SUPPLIES AS REQUIRED FOR ALL ELECTRIFIED DOOR LOCKING HARDWARE LOCATED ABOVE ADJACENT CEILINGS. PROVIDED BY DIV 8 DOOR HARDWARE SUPPLIER, TIED IN BY E.C.
- 12 GENERAL NOTE: ALL HARDWARE AND DEVICE INSTALLATIONS SHALL INTERFACE WITH EXISTING DOOR ACCESS CONTROL STATIONS.
- 13 APPLY 23 MIL SECURITY FILM ON ALL INTERIOR GLASS SURFACES BELOW 7'-0" AFF. PROVIDE ANCHORING ATTACHMENT SYSTEM AS SPECIFIED.
- 14 PROVIDE 5/16" SECURITY GLASS ON ALL DOORS AND GLASS TO 7'-0" AFF AS SPECIFIED.

HARDWARE / EQUIPMENT LEGEND (All hardware / equipment specifications shall comply with Lee County School standards, and be compatible with new or existing S2 Security Access control Systems)

1. NEW IPHONE IX SERIES.
2. EXISTING DESKTOP TWO WAY CONTROL STATION UNIT TO BE REPLACED WITH INTERFACE AS SPECIFIED.
3. CARD READER UNIT: HID IC CLASS CARD READER, MODEL S2-600PTNNEK00460-S2SEC-MINI-MULLION VERSION WHERE REQUIRED PROVIDED BY THE DIV 17 ACCESS CONTROL CONTRACTOR.
4. ACCESS CONTROL SYSTEM FIELD PANEL: S2 NETWORK NODE, S2-NN-E2R-WM HOUSING UP TO SEVEN (7) S2 APPLICATION BLADES, SUPPORTING UP TO 14 DOORS WITH NETWORK DROP - PROVIDED BY THE DIVISION 17 ACCESS CONTROL CONTRACTOR. ELECTRICAL CONTRACTOR TO PROVIDE ELECTRICAL POWER.
5. ACCESS CONTROL BASE STATION COMPUTER SOFTWARE PROGRAM INSTALLED ON OWNER'S PC FOR SOFTWARE CONTROL OF CONNECTED DOORS - PROVIDED BY THE DIVISION 17 ACCESS CONTROL CONTRACTOR.
6. SURFACE MOUNTED ELECTRIC STRIKE: HES 9600 SERIES PROVIDED AND INSTALLED BY DIV 8 DOOR HARDWARE SUPPLIER.
7. ELECTRIFIED MORTISE LOCKSET: SCHLAGE L909X SERIES PROVIDED AND INSTALLED BY DIV 8 DOOR HARDWARE SUPPLIER.
8. NOT USED.
9. DOOR CONTACTS FOR NEW DOORFRAME: RECESSED DOOR SWITCH SETS GRI 180 SERIES, 195-12WG, BY GEORGE RISK INDUSTRIES DOUBLE POLE, DOUBLE THROW, WIDE GAP PROVIDED BY THE DIVISION 17 ACCESS CONTROL CONTRACTOR. ELECTRICAL CONTRACTOR TO PROVIDE RACEWAY TO DOOR FRAME.
10. DOOR CONTACTS FOR EXISTING DOORFRAME: SURFACE MOUNT SWITCH SETS GRI 4460 SERIES, 4460A MINIATURE ALUMINUM GEORGE RISK INDUSTRIES - PROVIDED BY THE DIVISION 17 ACCESS CONTROL CONTRACTOR. ELECTRICAL CONTRACTOR TO PROVIDE RACEWAY TO DOOR FRAME.
11. ARMORED DOOR CORDS: ENFORCER SD-966-S180 SURFACE MOUNTED CORD WITH DIE-CAST ALUMINUM END CAPS, BY SECO-LARM U.S.A. - PROVIDED BY THE DIVISION 17 ACCESS CONTROL CONTRACTOR. ELECTRICAL CONTRACTOR TO PROVIDE RACEWAY TO HINGE SIDE OF DOOR AT 36" AFF. DOORS WITH EPT WILL NOT REQUIRE ARMORED DOOR CORDS.
12. POWER SUPPLIES: FOR ALL POWERED LOCKING HARDWARE / EXIT DEVICES PROVIDED AND INSTALLED BY DIV 8 DOOR HARDWARE SUPPLIER.
13. VON DUPRIN QUBET ELECTRIC LATCH RETRACTION QEL EXIT DEVICE 9899 SERIES PROVIDED AND INSTALLED BY DIV 8 DOOR HARDWARE SUPPLIER.
14. EPT ELECTRIC POWER TRANSFER (FRAME TO DOOR WIRING PATH); VON DUPRIN MODELS EPT 2, EPT 10, EPT10C (AS APPLICATION REQUIRES), FOR USE WITH VON DUPRIN QEL EXIT DEVICES, PROVIDED AND INSTALLED BY DIV 8 DOOR HARDWARE SUPPLIER.
15. ELECTRONIC CONVERSION KITS FOR EXISTING NON-POWERED DOOR EXIT DEVICES PROVIDED AND INSTALLED BY DIVISION 8 DOOR HARDWARE SUPPLIER. KIT SHALL BE COMPATIBLE WITH EXISTING EXIT DEVICES.
16. WORK OF ALL DIVISIONS SPECIFICATIONS BY GENERAL CONTRACTOR INCLUDING COORDINATION OF WORK BY DIVISION 16 AND 17 SUBCONTRACTORS. WORK IS TO BE COMPLETE IN ALL RESPECTS, INCLUDING POWER AND CONNECTIONS FOR BOTH NEW AND RELOCATED ITEMS AS SHOWN.
17. GENERAL NOTE: PATCH AND RESTORE ALL DISTURBED FINISHES TO MATCH ADJACENT SURFACES, I.E. INCLUDING BU NOT LIMITED TO FLOORING, PAINT, WALLS, CEILINGS, ETC.

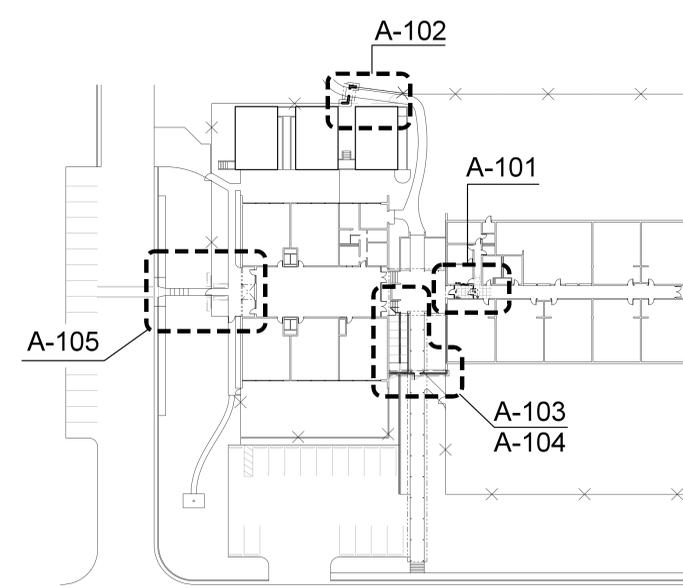

Key Plan
NTS

No.	Date	Revised per	Owner/Architect	Revision
1	12-19-24			

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REGISTERED ARCHITECT
JAMES GRAY HITE
NO. 3
GREENVILLE, NC

REGISTERED PROFESSIONAL
M.E. ASSOCIATES, P.C.
NUMBER 418
GREENVILLE, NC

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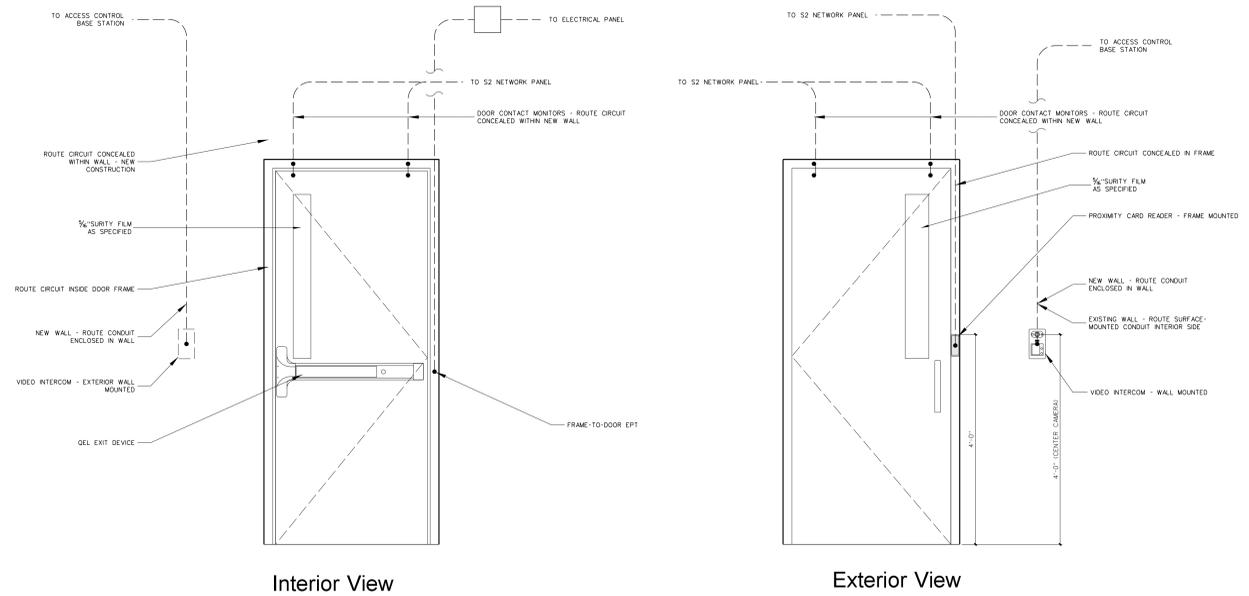
Project No. 22238
Date: 13 March 2023
Drawing No. **A 101**

PLAN KEY NOTE / ACCESS CONTROL NOTES / GENERAL NOTES
(Apply Throughout)


- 1 INSTALL SURFACE MOUNTED PROXIMITY CARD READER UNIT AS SHOWN 48" AFF TO TOP OF UNIT.
- 2 GENERAL NOTE: PROVIDE DOOR CONTACTS ON ALL ACCESS CONTROLLED DOORS.
- 3 GENERAL NOTE: ALL ACCESS CONTROL NETWORK NODES TO BE PROVIDED IN THE SCHOOL IDF AND IDF ROOMS FINAL LOCATIONS AS DIRECTED BY OWNER.
- 4 GENERAL NOTE: PROVIDE ALL POWER SUPPLIES CONDUIT AND WIRING AS REQUIRED FOR ALL ELECTRIFIED DOOR LOCKING HARDWARE OBTAIN POWER FROM ADJACENT BUILDING CIRCUIT.
- 5 GENERAL NOTE: ALL HARDWARE AND DEVICE INSTALLATIONS SHALL INTERFACE WITH EXISTING DOOR ACCESS CONTROL STATIONS.

HARDWARE / EQUIPMENT LEGEND (All hardware / equipment specifications shall comply with Lee County School standards, and be compatible with new or existing S2 Security Access control Systems)

1. CARD READER UNIT: HD IGLASS CARD READER MODEL S2-900TNNK0460-S2SEC, MINI-MULLION VERSION WHERE REQUIRED, PROVIDED BY THE DIV 17 ACCESS CONTROL CONTRACTOR.
2. ACCESS CONTROL SYSTEM FIELD PANEL: S2 NETWORK NODE S2-NN-ER-VM HOUSING UP TO SEVEN (7) S2 APPLICATION BLADES SUPPORTING UP TO 14 DOORS WITH NETWORK DROP - PROVIDED BY THE DIVISION 17 ACCESS CONTROL CONTRACTOR, ELECTRICAL CONTRACTOR TO PROVIDE ELECTRICAL POWER.
3. ACCESS CONTROL BASE STATION: COMPUTER SOFTWARE PROGRAM, INSTALLED ON OWNER'S PC, FOR SOFTWARE CONTROL OF CONNECTED DOORS - PROVIDED BY THE DIVISION 17 ACCESS CONTROL CONTRACTOR.
4. DOOR CONTACTS FOR EXISTING DOOR FRAME: SURFACE MOUNT SWITCH SETS GRI 440 SERIES, 4463A MINATURE ALUMINUM GEORGE RISK INDUSTRIES - PROVIDED BY THE DIVISION 17 ACCESS CONTROL CONTRACTOR, ELECTRICAL CONTRACTOR TO PROVIDE RACEWAY TO DOOR FRAME.
5. POWER SUPPLIES: FOR ALL POWERED LOCKING HARDWARE / EXIT DEVICES PROVIDED AND INSTALLED BY DIV 8 DOOR HARDWARE SUPPLIER.
6. VON DUPRIN QUIET ELECTRIC LATCH RETRACTION: OEL EXIT DEVICE 9899 SERIES PROVIDED AND INSTALLED BY DIV 8 DOOR HARDWARE SUPPLIER.
7. EPT ELECTRIC POWER TRANSFER (FRAME TO DOOR WIRING PATH): VON DUPRIN MODELS EPT 2, EPT 10, EPT100 (AS APPLICATION REQUIRES); FOR USE WITH VON DUPRIN OEL EXIT DEVICES, PROVIDED AND INSTALLED BY DIV 8 DOOR HARDWARE SUPPLIER.
8. WORK OF ALL DIVISIONS SPECIFICATIONS BY GENERAL CONTRACTOR INCLUDING COORDINATION OF WORK BY DIVISION 16 AND 17 SUBCONTRACTORS WORK IS TO BE COMPLETE IN ALL RESPECTS, INCLUDING POWER AND CONNECTIONS FOR BOTH NEW AND RELOCATED ITEMS AS SHOWN.
9. GENERAL NOTE: PATCH AND RESTORE ALL DISTURBED FINISHES TO MATCH ADJACENT SURFACES; IE INCLUDING BU NOT LIMITEDS TO FLOORING, PAINT, WALLS, CEILINGS, ETC.




101.4 SECURITY ELECTRICAL ACCESS HAEDWARE DETAILS
SCALE: 3/4" = 1'-0"

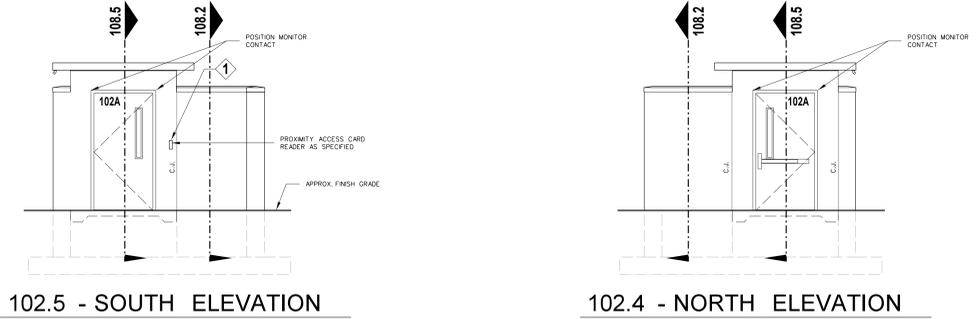


102.5 - SOUTH ELEVATION **102.4 - NORTH ELEVATION**

- SECURE EXIT DOOR NOTES:**
1. ALL DOORS TO BE 1-75THK x 40"W x 80"H
 2. ALL FRAMES SHALL BE 4" WIDE ALUMINUM AND RECEIVE HINGES AS SPECIFIED.
 3. ALL DOORS TO BE INSTALLED WITH EXIT DEVICE AND CLOSURE WITH BACKSTOP AT PAIRS OF DOORS. PULL SIDE PROVIDE PULL OR LEVER RIGHT SIDE ONLY AND KEYS MULLIONS
 4. PROVIDE CYLINDERS FOR KEYS MULLIONS SUPPLIED BY ALUMINUM DOOR
 5. ALL DOOR OPENINGS TO RECEIVE S2 ELECTRONICS WITH THROUGH-HINGE DELIVERY TO EXIT DEVICES, RIGHT SIDE ONLY AT PAIRS. ROUGH INS, CONDUITS, AND S2 COMPONENTS AND WIRING BY OWNER VENDOR, COORDINATION BY GC.
 6. ALL IMPACT SAFETY VIEW GLASS SHALL HAVE 16mm 3M SECURITY FILM AS SPECIFIED.

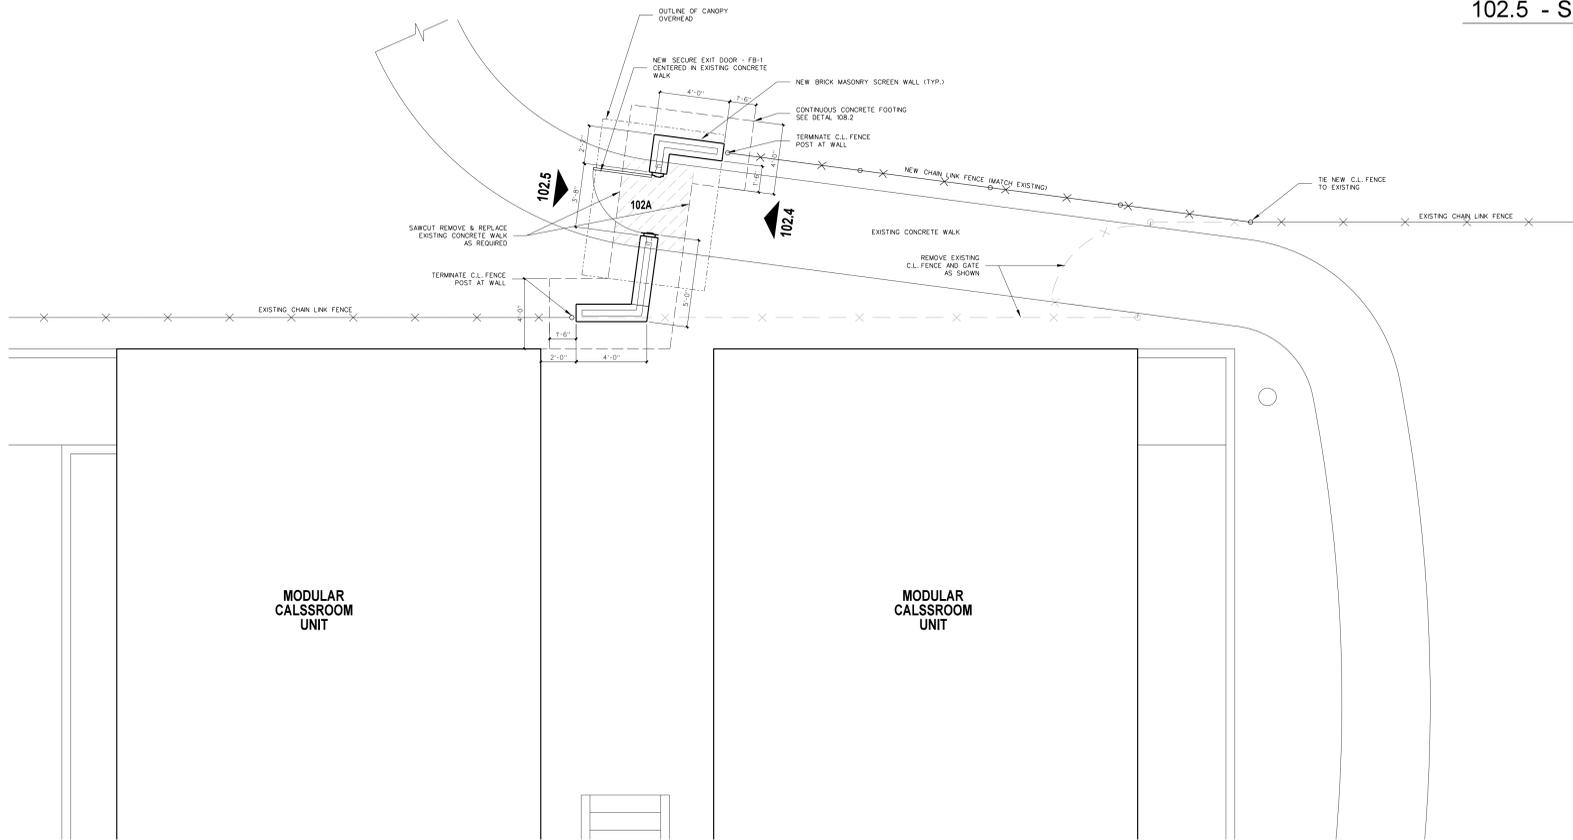

102.3 NEW SECURITY SCREEN WALL - ELEVATIONS
SCALE: 1/4" = 1'-0"

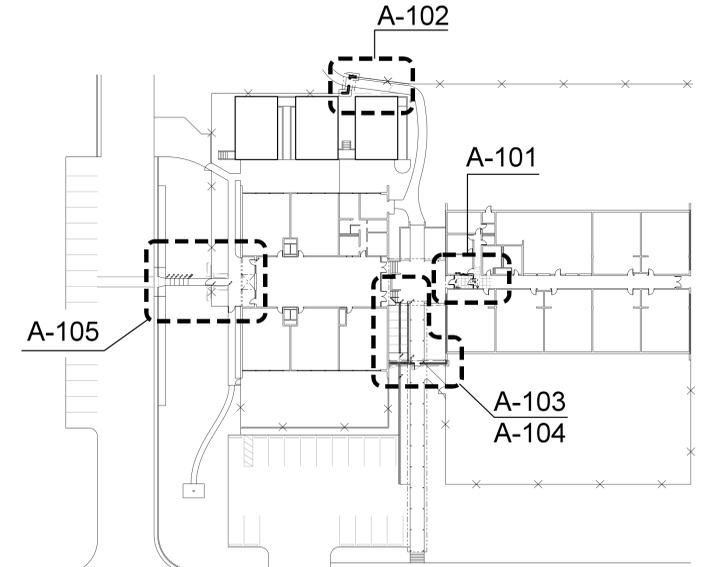

102.1 PLAN - WEST AT MODULAR UNTS
SCALE: 1/4" = 1'-0"

Key Plan
NTS


No.	Date	Revision
1	12-19-24	Revised per Architect

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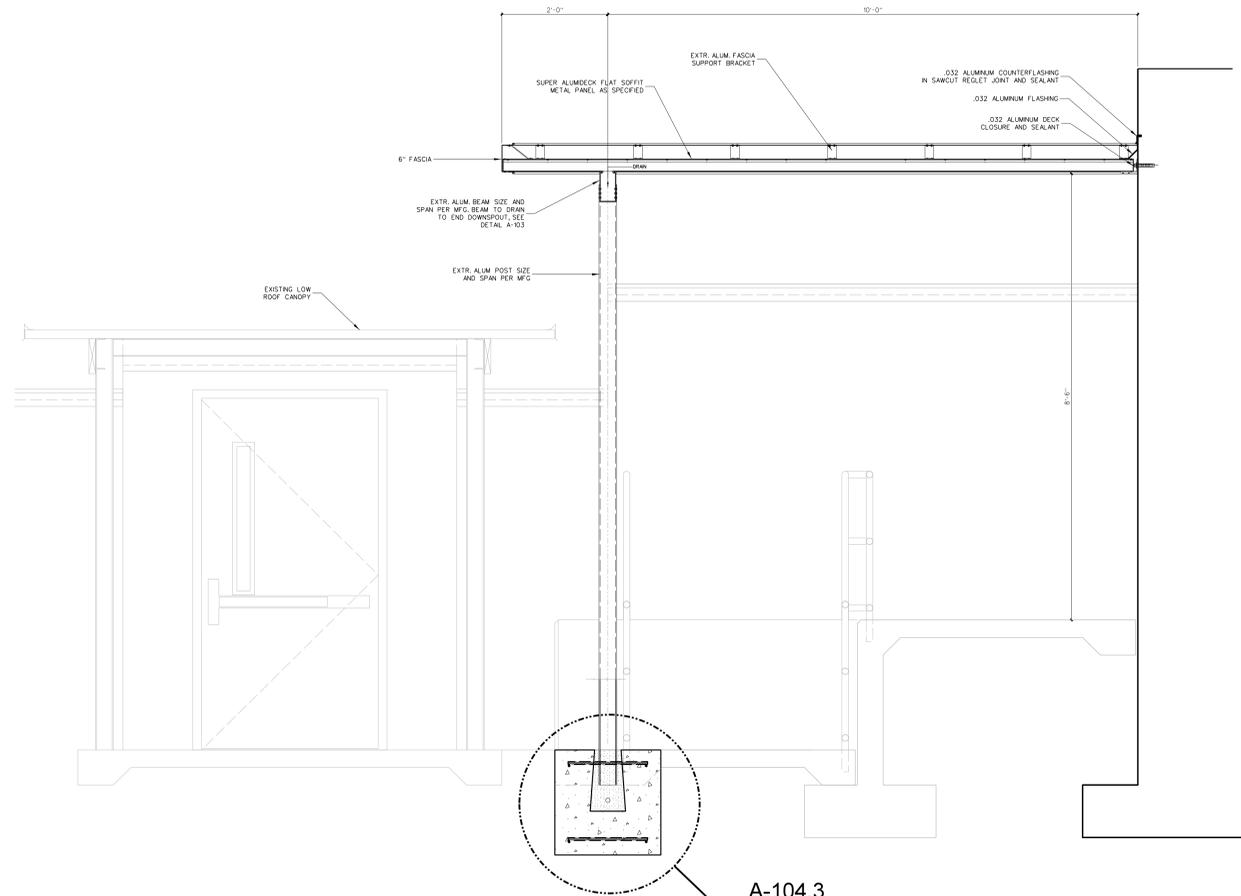


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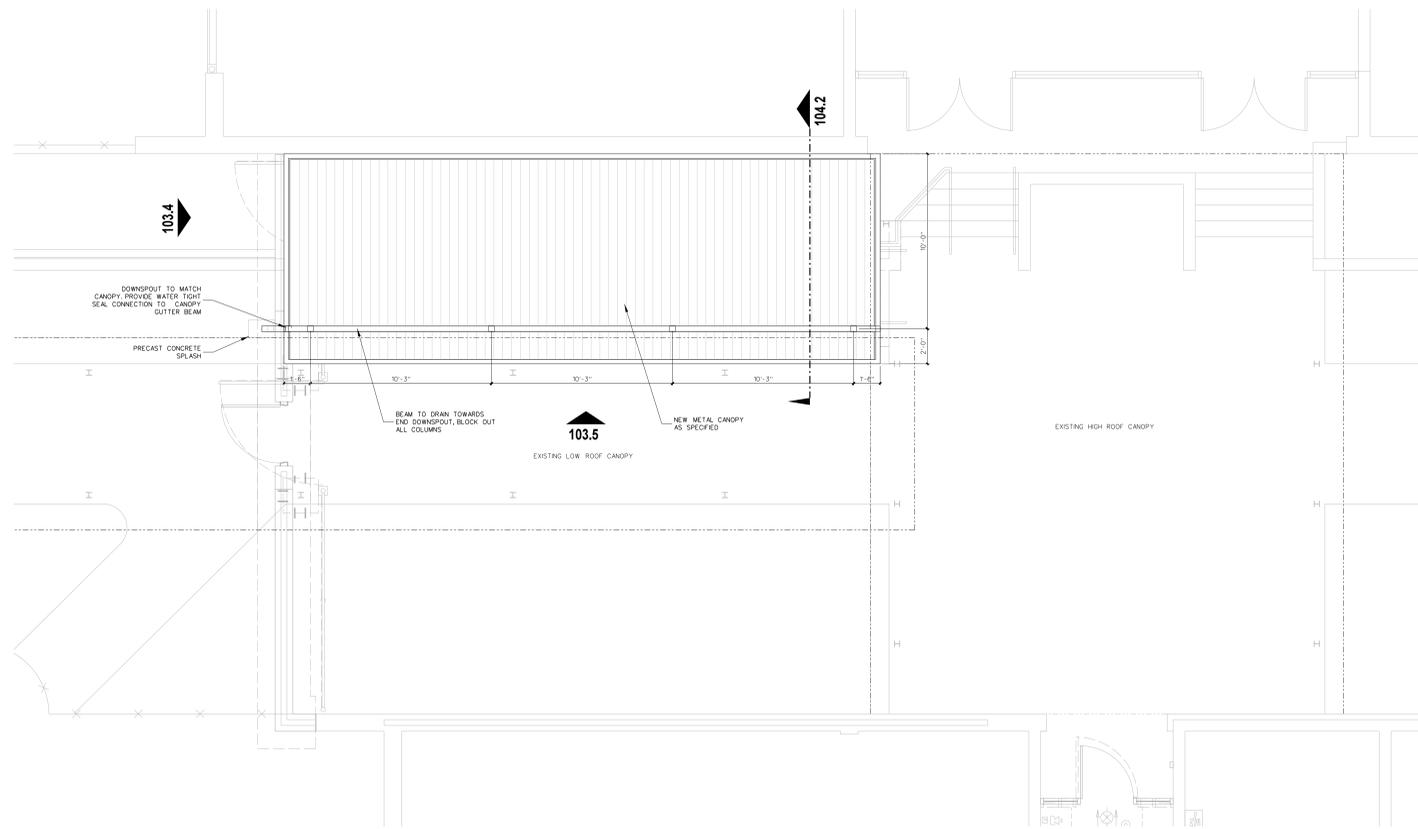
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Drawing no.	A 102




104.3 TYPICAL CANOPY FOOTING DETAIL
SCALE: 1 1/2" = 1'-0"

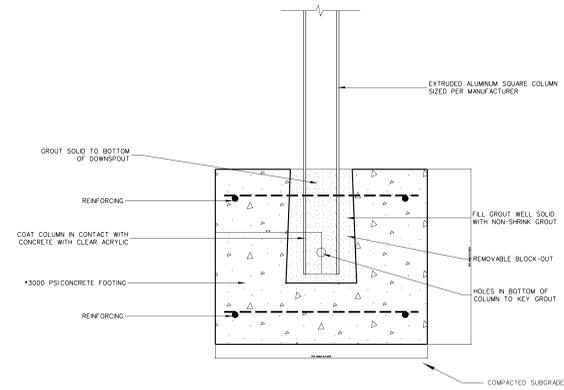

104.2 TYPICAL CANOPY SECTION
SCALE: 1 1/2" = 1'-0"



104.1 METAL CANOPY ROOF PLAN
SCALE: 1/4" = 1'-0"

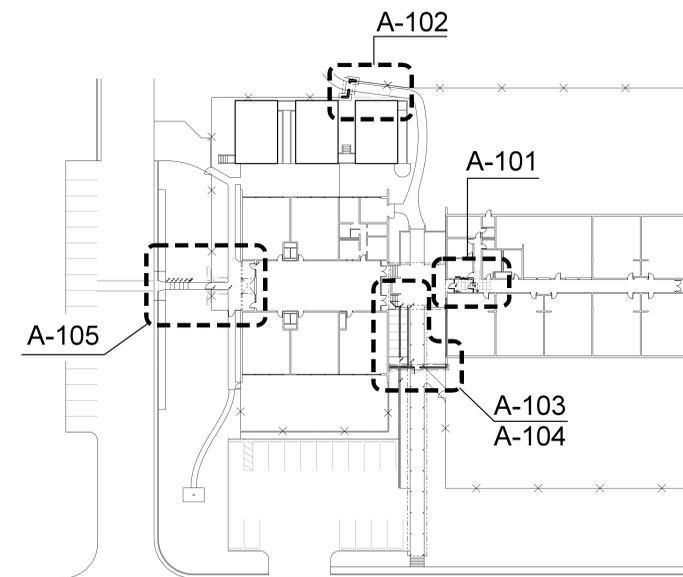

Key Plan
NTS


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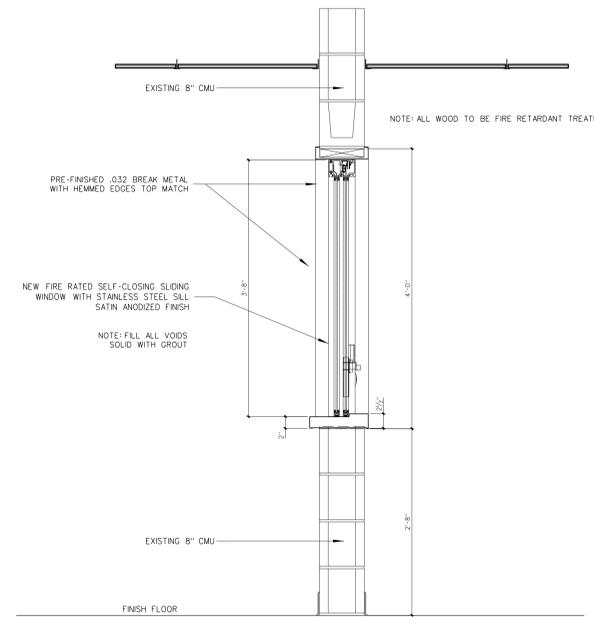
Project No.	22238
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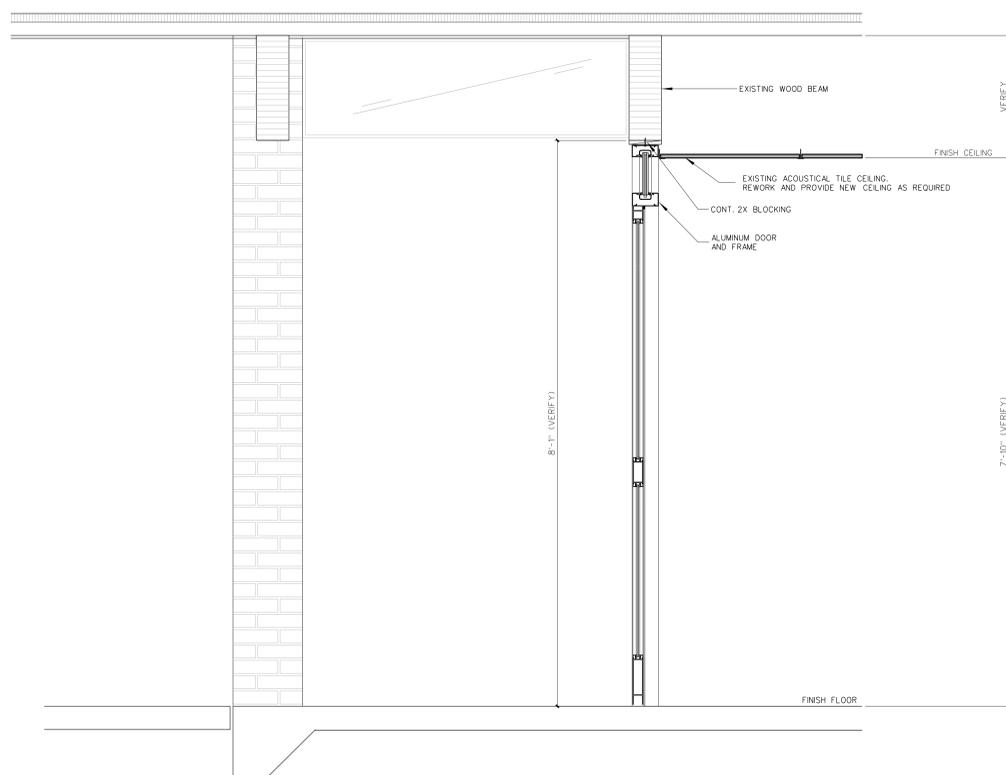
NEW CONSTRUCTION
106.4.2 JAMB

EXISTING CONSTRUCTION
106.4.1 JAMB


106.4 DOOR FRAME DETAILS
SCALE: 3" = 1'-0"



106.3 SECTION AT NEW CHECK-IN WINDOW
SCALE: 1" = 1'-0"

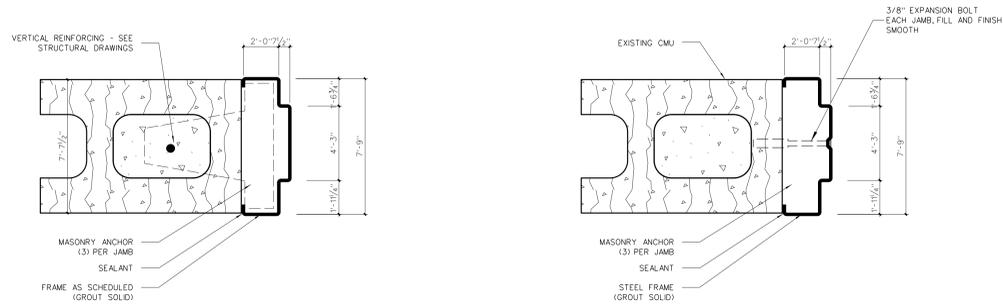

106.2 SECTION AT NEW STOREFRONT
SCALE: 1" = 1'-0"

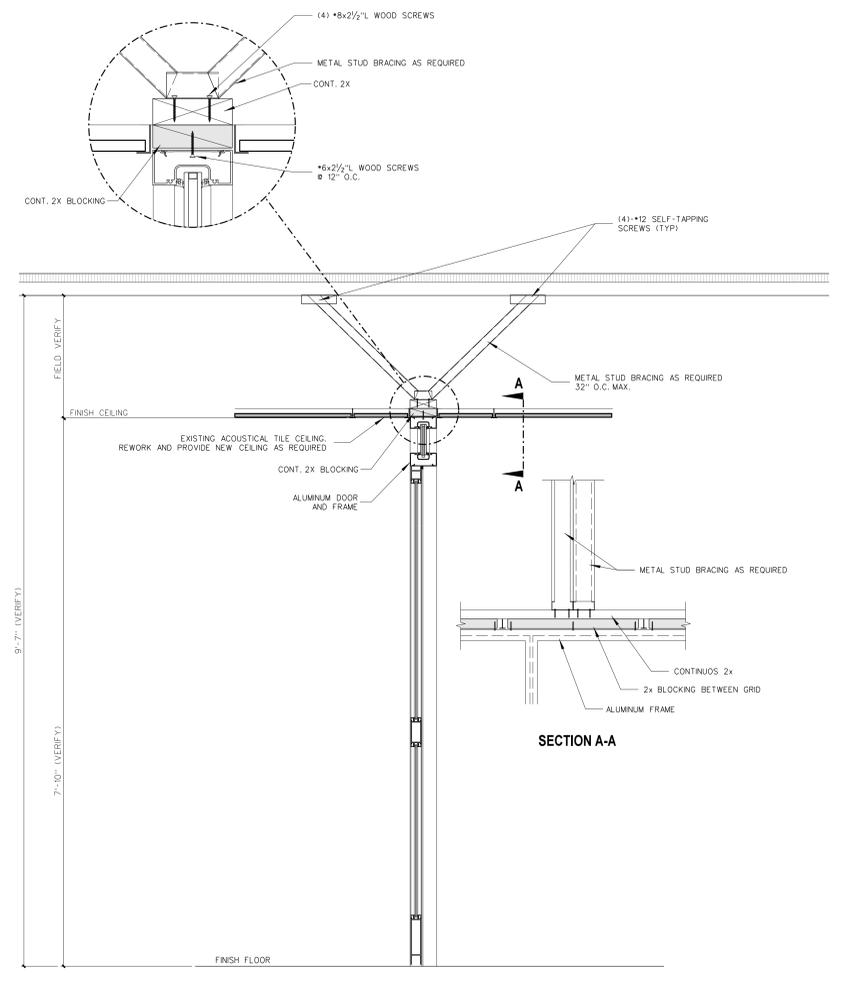

106.1 SECTION AT NEW STOREFRONT
SCALE: 1" = 1'-0"


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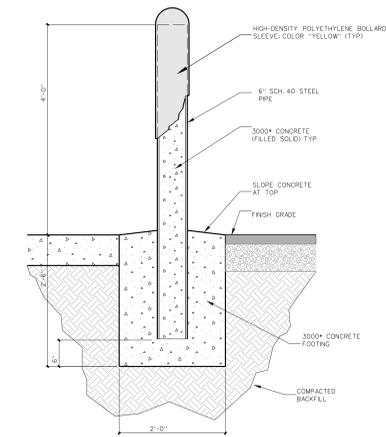


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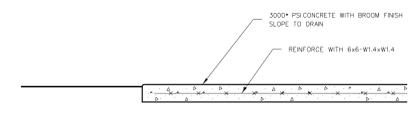
Project No.	22238
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Drawing no.	A 106




107.8 TYPICAL CANOPY FOOTING DETAIL
SCALE: 1 1/2" = 1'-0"

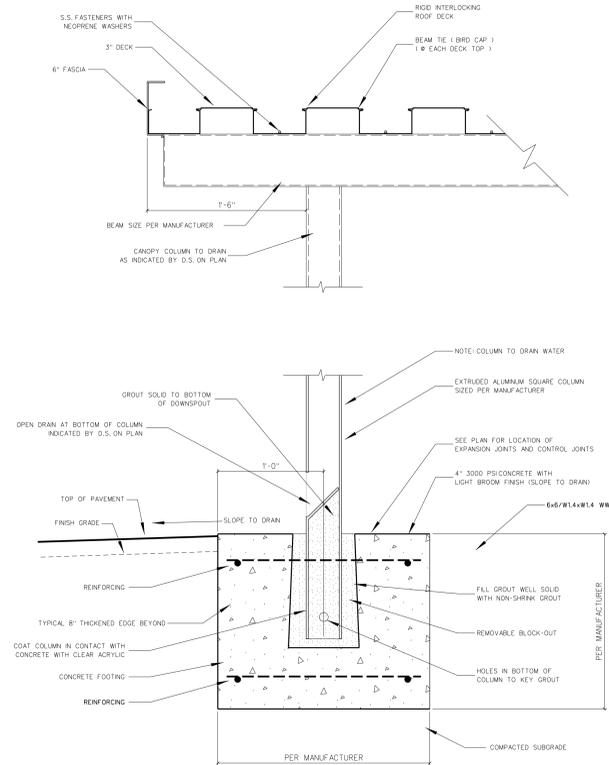

107.7 STEEL BOLLARD DETAIL
SCALE: 3/4" = 1'-0"




107.3 LIGHT-DUTY CONCRETE SLAB
SCALE: 3/4" = 1'-0"

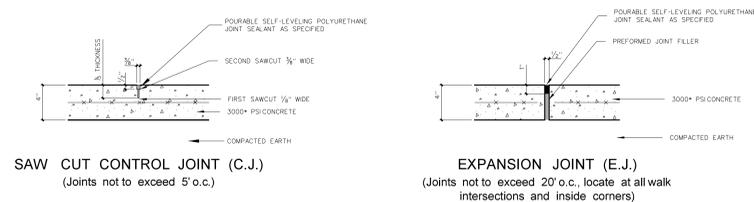


SAW CUT CONTROL JOINT (C.J.)
(Joints not to exceed 5' o.c.)

EXPANSION JOINT (E.J.)
(Joints not to exceed 20' o.c., locate at all walk intersections and inside corners)

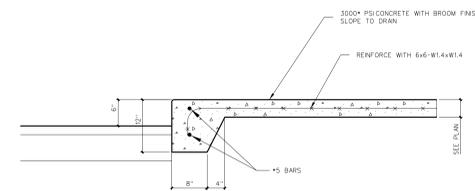


107.4 LIGHT-DUTY MONOLITHIC CURB
SCALE: 3/4" = 1'-0"

NOTE: PROVIDE SAWCUT JOINTS AT 5'-0" O.C. VERIFY LAYOUT WITH ARCHITECT. SAWCUT JOINTS MIN. 1/2" SLAB THICKNESS NO MORE THAN 24 HOURS AFTER PLACEMENT. SEE JOINT DETAILS PROVIDE 1/2" EXPANSION JOINTS AS SPECIFIED. 30'-0" O.C. MAX. VERIFY LAYOUT WITH ARCHITECT

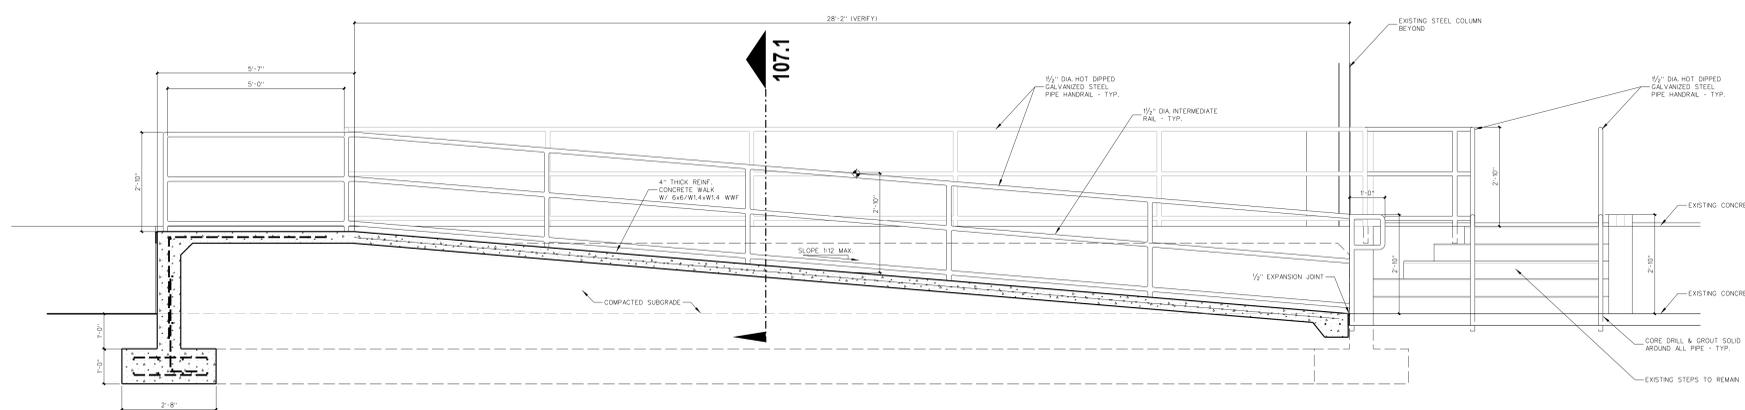

107.2 SECTION @ CONCRETE RAMP
SCALE: 1/2" = 1'-0"

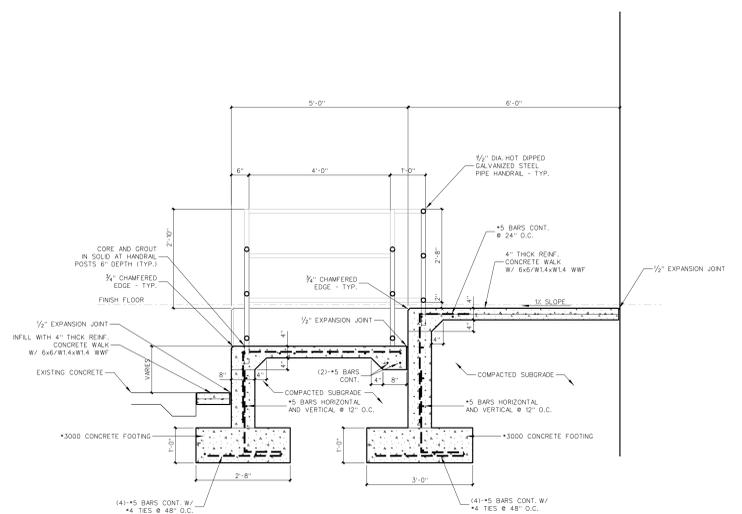

107.1 SECTION @ CONCRETE RAMP/WALK
SCALE: 1/2" = 1'-0"

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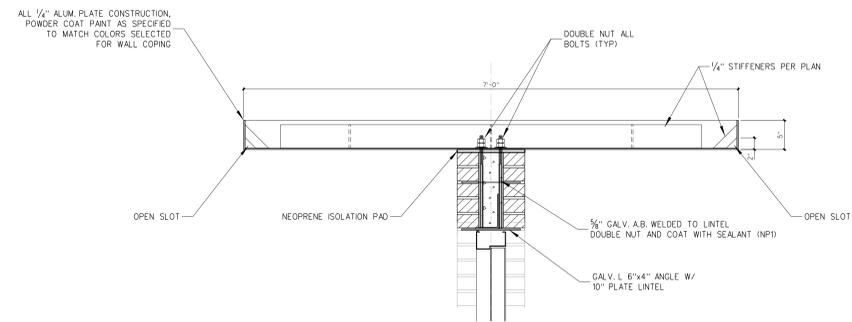
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Project No. 22238


Date: 13 March 2023

Drawing no.


A
107



108.5 SCREEN WALL SECTION AT DOOR
SCALE: 1" = 1'-0"

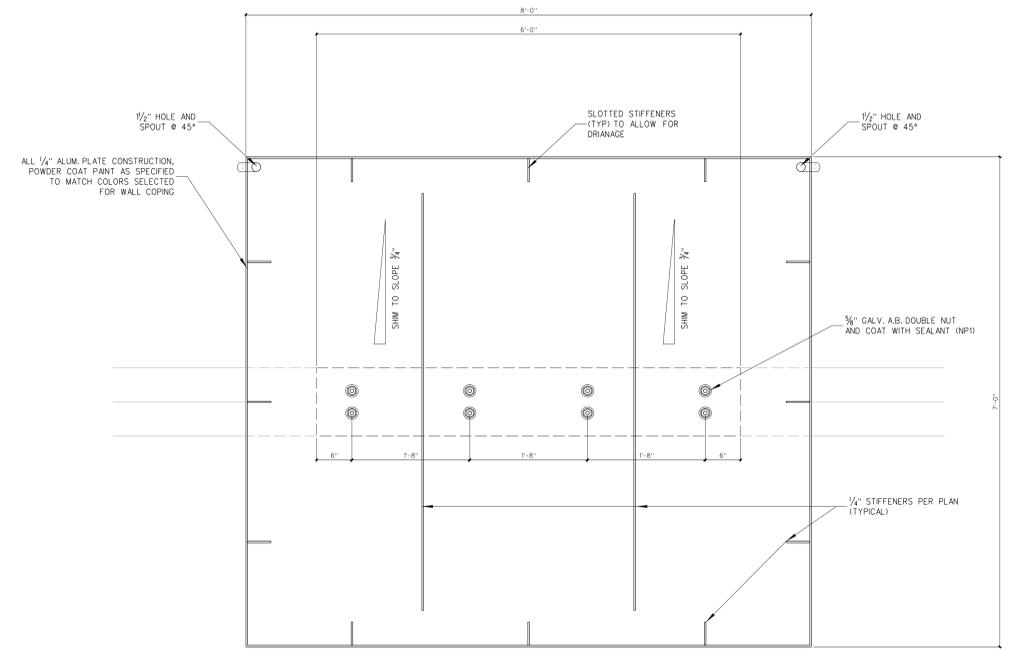


108.4 PLAN VIEW METAL ROOF DETAIL AT DOOR
SCALE: 1" = 1'-0"

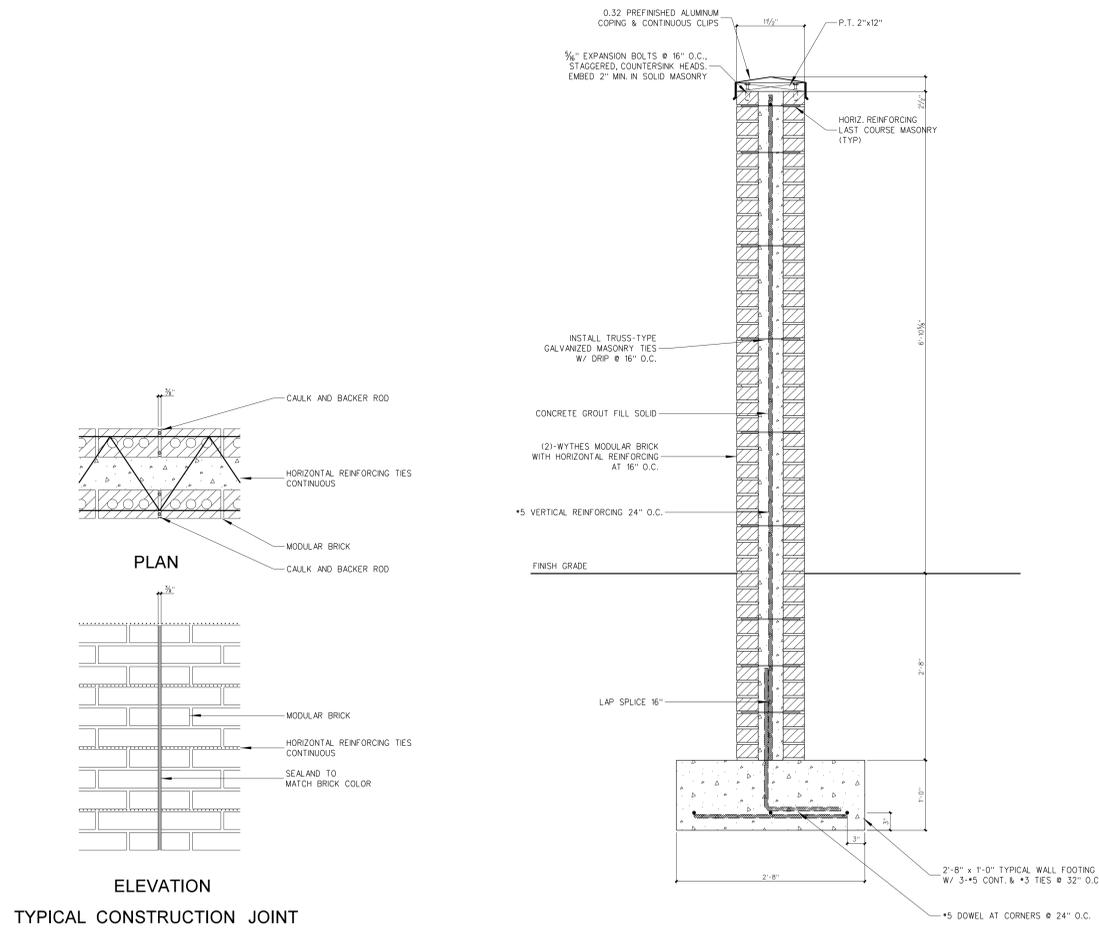

108.3 MASONRY JOINT DETAIL
SCALE: 3/4" = 1'-0"

108.2 TYPICAL BRICK MASONRY SCREEN WALL
SCALE: 1" = 1'-0"

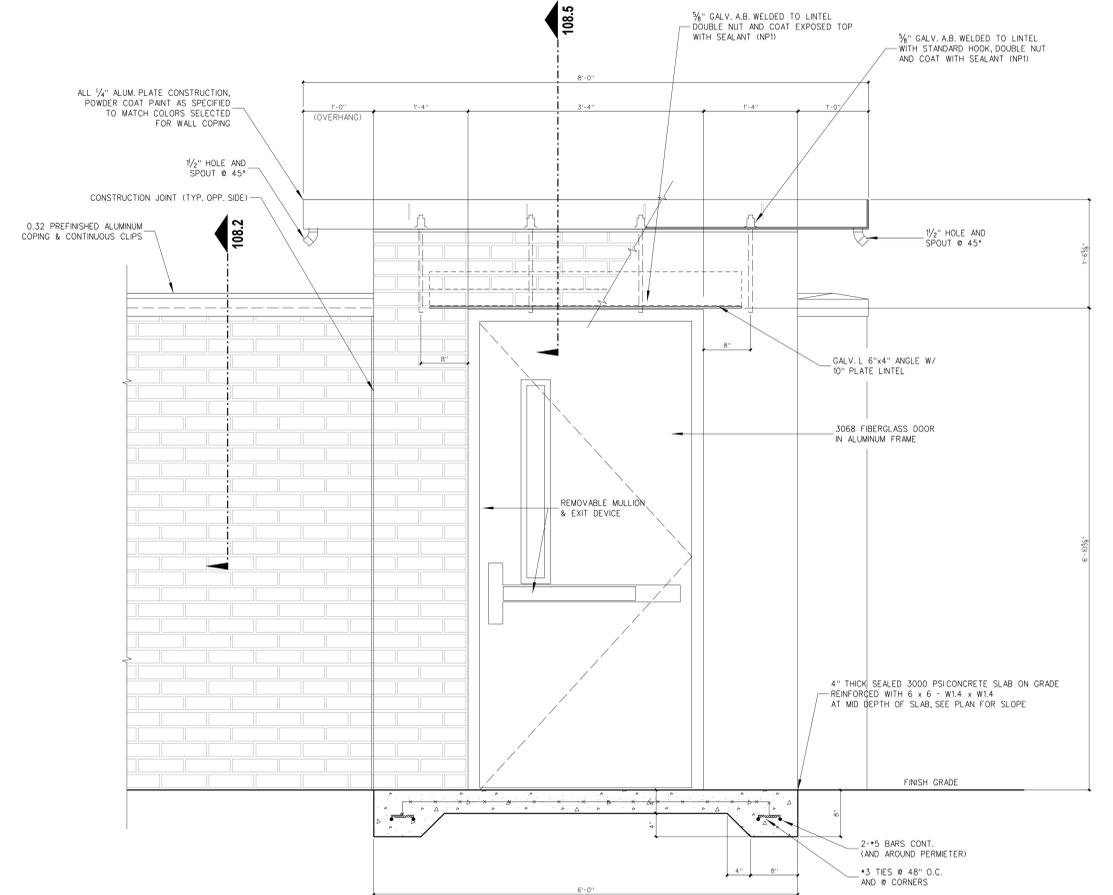

108.1 ELEVATION METAL ROOF DETAIL AT DOOR
SCALE: 1" = 1'-0"

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Project No.	22238
Date:	13 March 2023
Drawing no.	A 108